### BALDWIN AIRPORT IMPROVEMENTS

### CIVIL GRADING - PRELIMINARY DESIGN NOT FOR CONSTRUCTION

DRAWING LIST				
DRAWING NO.	DESCRIPTION	ISSUE		
C001	COVER PAGE AND DRAWING INDEX	0		
C002	PROPOSED SITE LAYOUT OVERVIEW	0		
C003	PLAN AND PROFILE SHEET 1 OF 2	0		
C004	PLAN AND PROFILE SHEET 2 OF 2	0		
C005	GRADING PLAN SHEET 1 OF 2	0		
C006	GRADING PLAN SHEET 2 OF 2	0		
C007	EROSION AND SEDIMENT CONTROL PLAN SHEET 1 OF 2	0		
C008	EROSION AND SEDIMENT CONTROL PLAN SHEET 2 OF 2	0		
C009	DETAILS SHEET 1 OF 3	0		
C010	DETAILS SHEET 2 OF 3	0		
C011	DETAILS SHEET 3 OF 3	0		

#### **GENERAL NOTES**

Attachment 3

- SCOPE OF WORKS
- 1.1. DRAWINGS PROVIDE A CIVIL GRADING PRELIMINARY DESIGN IN SUPPORT OF THE OWNER'S SITE IMPROVEMENTS.
- 1.1.1. RUNWAY AND TAXIWAY GRADES TO COMPLY WITH TP 312 5<sup>TH</sup> EDITION. OPERATIONS TO BE NON-INSTRUMENT, AIRCRAFT GROUP NUMBER II. 1.1.2. ROADWAY GRADES TO COMPLY WITH TOWN OF GEORGINA DESIGN CRITERIA, MINISTRY OF TRANSPORTATION ONTARIO SUPPLMENT TO THE TAC GEOMETRIC DESIGN GUIDE FOR CANADIAN ROADWAYS, TAC GEOMETRIC DESIGN GUIDE FOR CANADIAN ROADWAYS.

  1.2. PAVEMENT — RUNWAY, TAXIWAY, HANGAR, RAMPED AREA AND ROADWAY PAVEMENT STRUCTURE TO BE DESIGNED BY OTHERS.

  1.3. RETAINING WALLS TO BE DESIGNED BY OTHERS.
- 2. TOPOGRAPHIC AND LEGAL BOUNDARY SURVEY
- 2.1. TOPOGRAPHIC SURVEY UNDERTAKEN BY GEOVERRA DATED JUNE 29, 2020.2.2. PROJECTION: 6 DEGREE UTM ZONE 17 (CENTRAL MERIDIAN 81 DEGREES WEST LONGITUDE)
- 2.3. HORIZONTAL DATUM: NAD83 CSRS
- 2.4. VERTICAL DATUM: CGVD28:1978
- 2.5. LEGAL BOUNDARY INFORMATION DERIVED FROM SURVEY UNDERTAKEN BY R.G. MCKIBBON LIMITED, ONTARIO LAND SURVEYORS DATED FEBRUARY 14, 2012. THE AUTHOR NOTES THAT THIS IS NOT A PLAN OF SURVEY; THEREFORE, LEGAL SURVEY SHOULD BE UNDERTAKEN FOR FUTURE DESIGN.

1	20/12/24	MT	NK/BS	JD	
FOR S	SAP APPRO	DVAL			
0	07/08/24	MT	NK/BS	JD	
FOR F	REVIEW				
Issue	Date	By	Chkd	Appd	

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**BALDWIN AIRPORT IMPROVEMENTS** 

Key Plan

Drawing Title COVER PAGE AND DRAWING LIST

NOT TO SCALE File Name 287943-ARUP-XX-XX-DR-C-XX-C001.DWG

Drawing Status **FOR REVIEW** 


287943-01 C001


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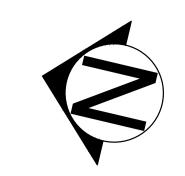
Report No. DS-2025-0028

IMAGE SOURCE: BING MAPS 2024

Page 1 of 11



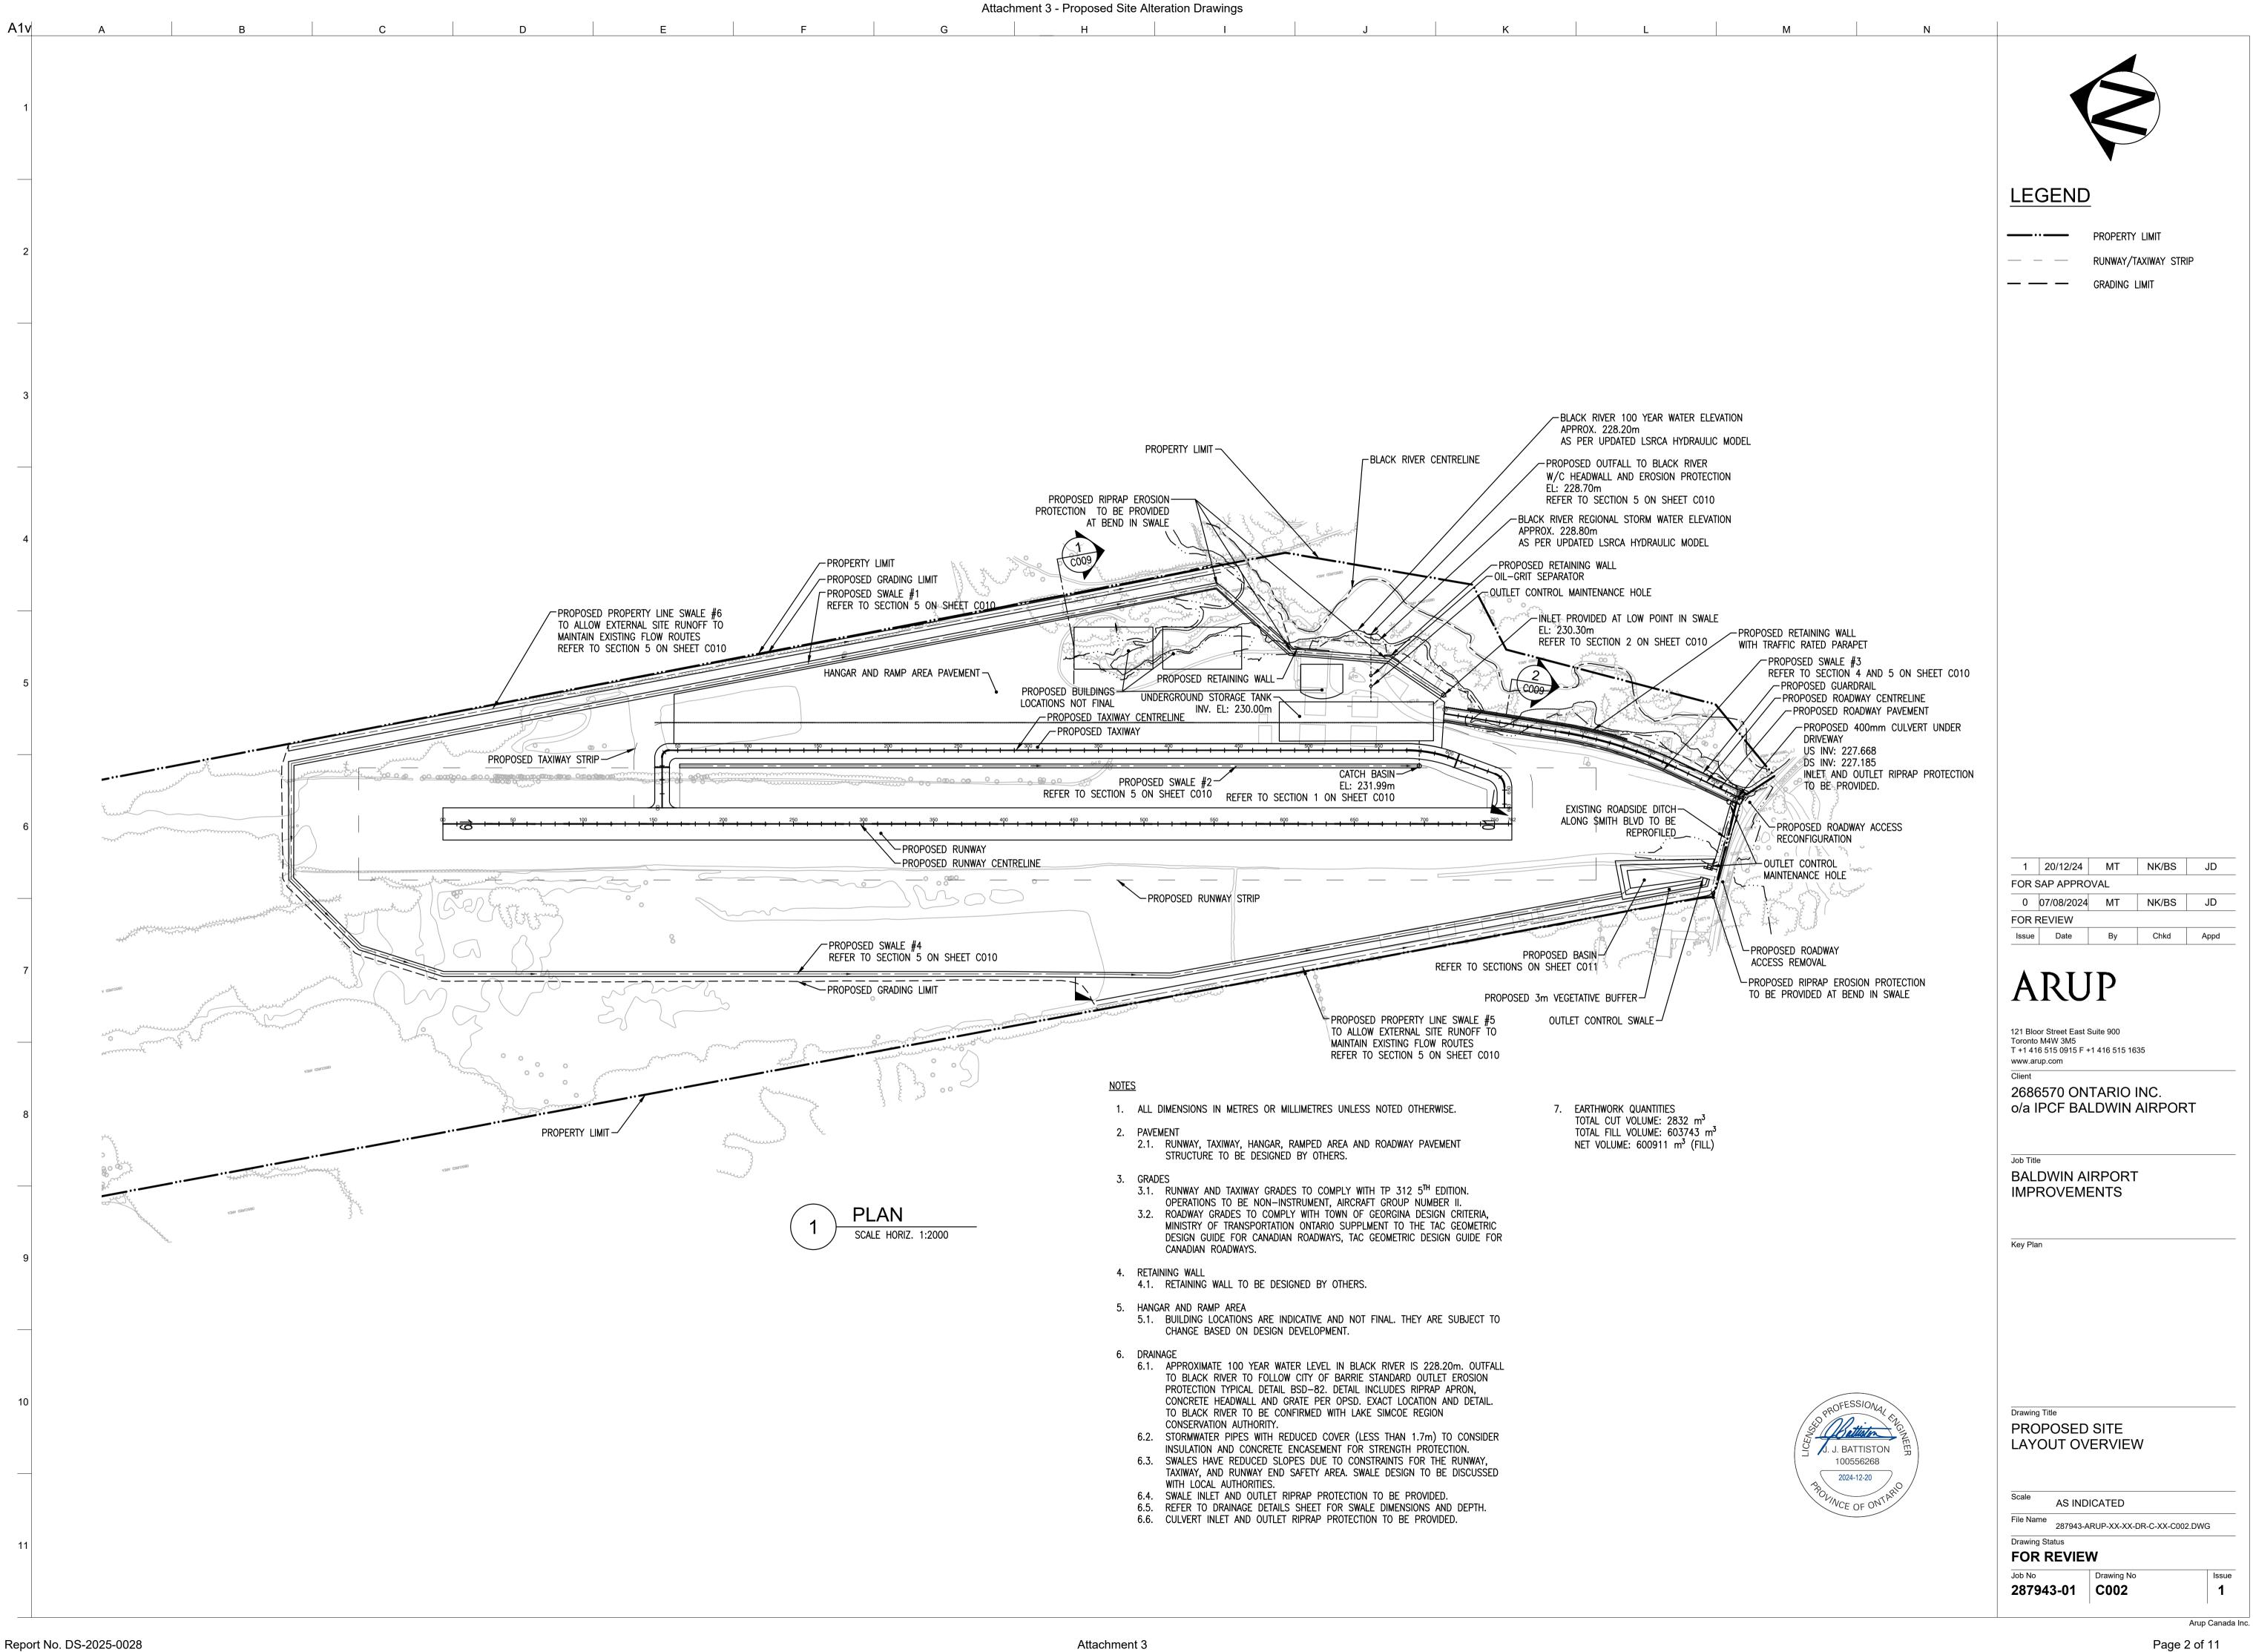

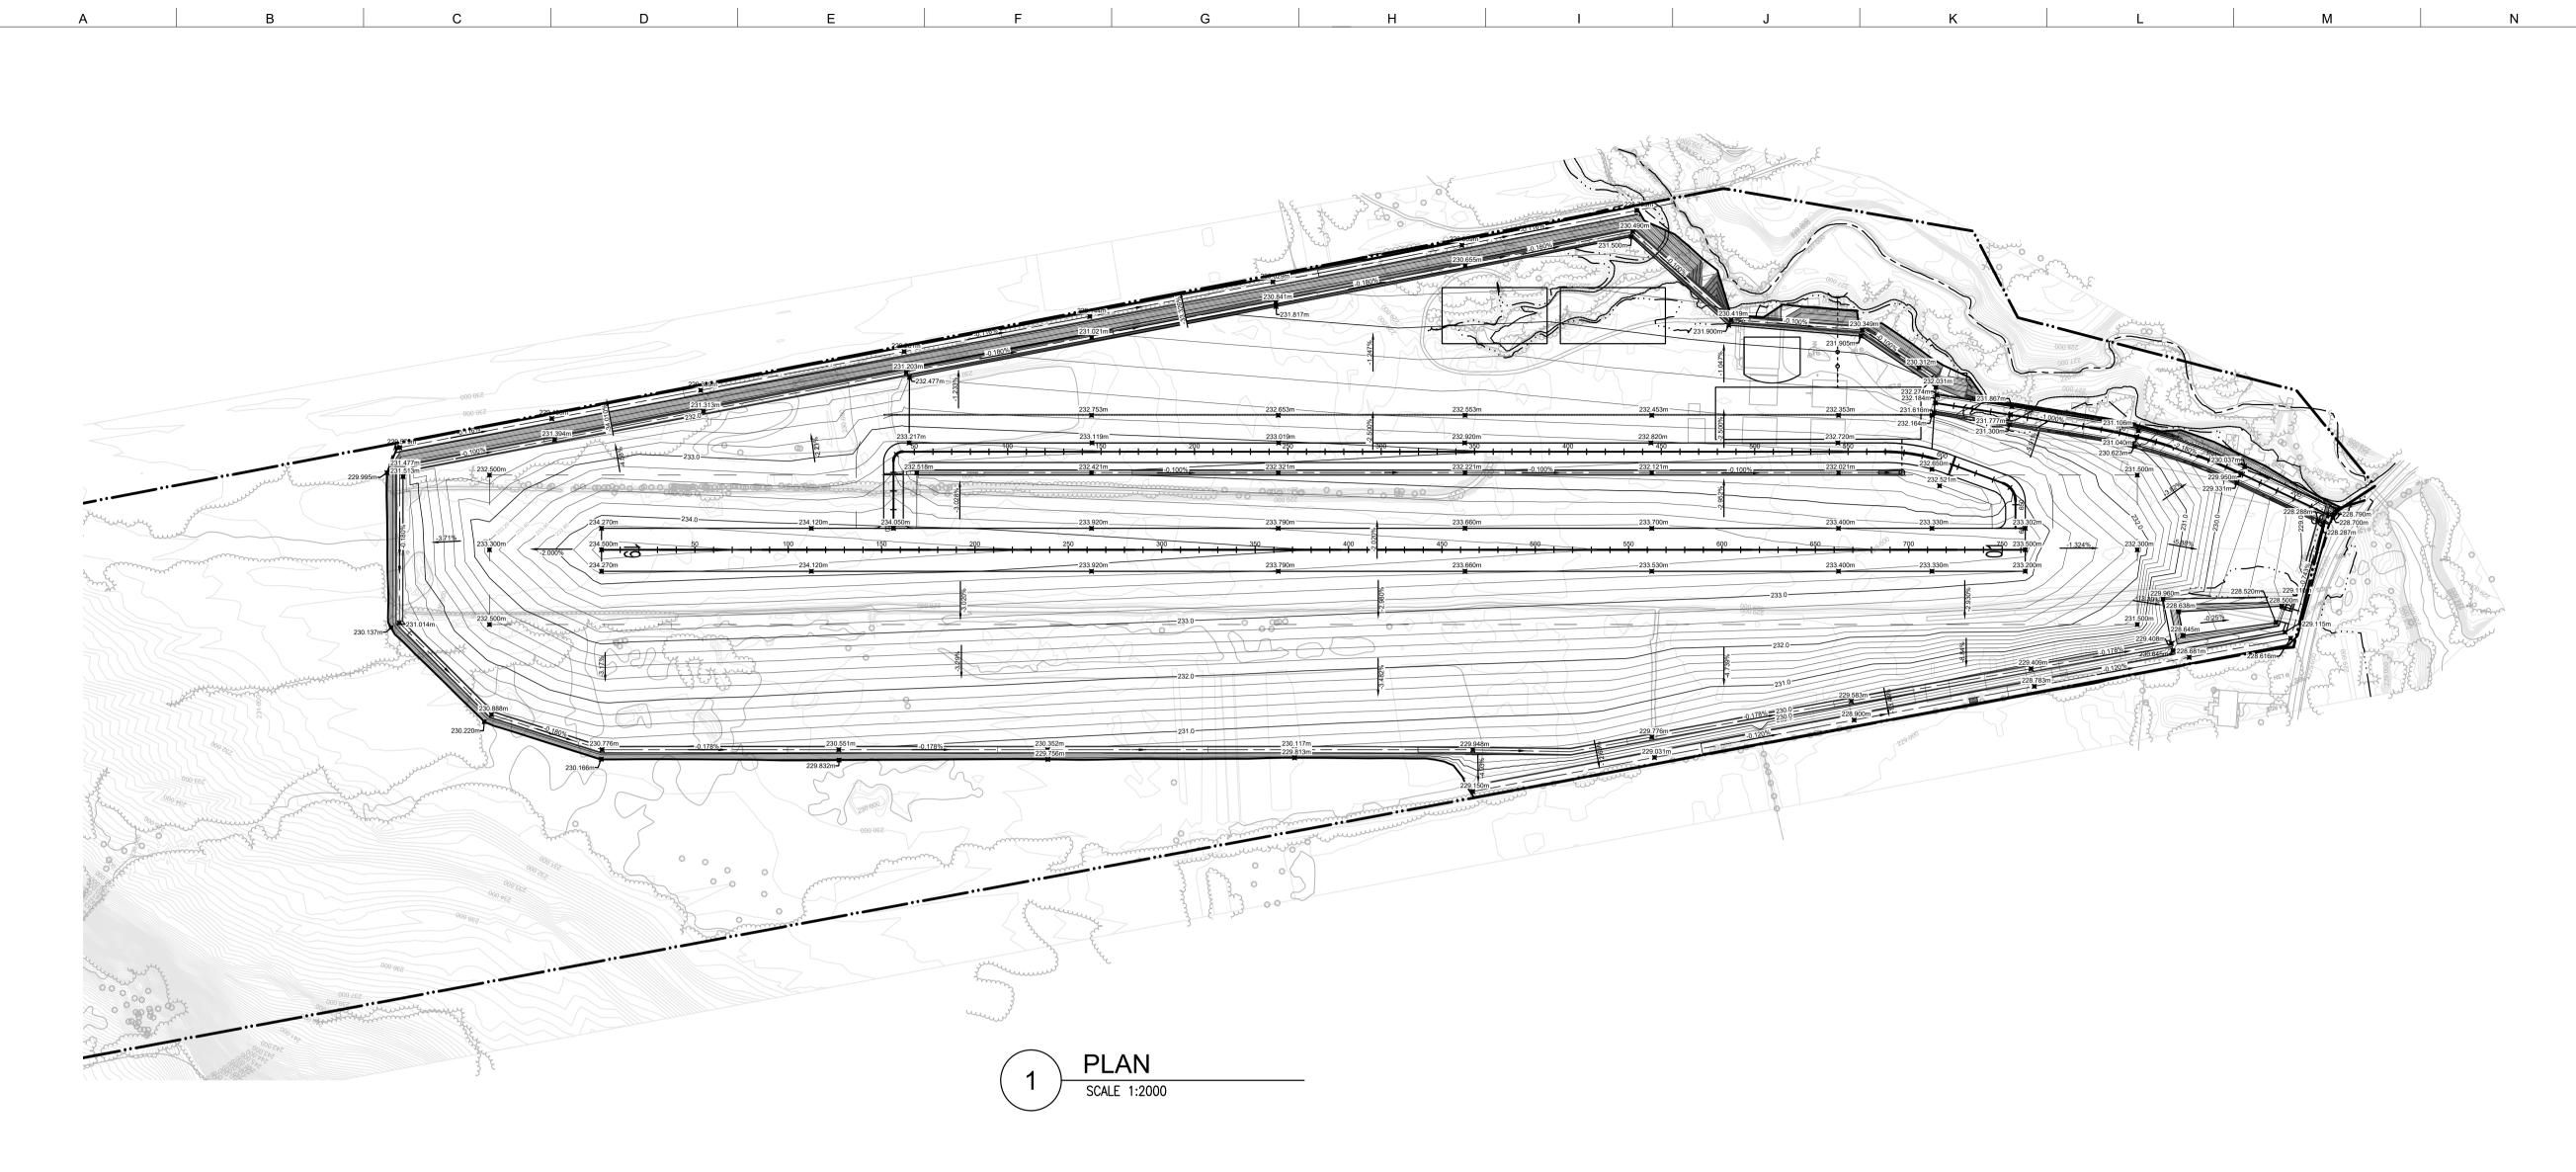

#### LEGEND

RUNWAY/TAXIWAY STRIP GRADING LIMIT

PROPOSED ELEVATION 230.000 EXISTING ELEVATION

> PROPOSED MINOR CONTOUR PROPOSED GROUND

PROPOSED MAJOR CONTOUR

EXISTING GROUND

1	20/12/2024	MT	NK/BS	JD
FOR S	SAP APPRO	VAL		
0	07/08/2024	MT	NK/BS	JD
FOR F	REVIEW			
Issue	Date	Ву	Chkd	Appd


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**BALDWIN AIRPORT IMPROVEMENTS** 

Key Plan



Drawing Title PLAN AND PROFILE SHEET 1 OF 2

AS INDICATED

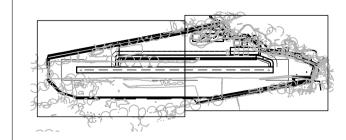Drawing Status

**FOR REVIEW** 

File Name 287943-ARUP-XX-XX-DR-C-XX-C003.DWG 287943-01 C003

Issue

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LONGSECTION SCALE HORIZ. 1:2000, VERT. 1:200 G =-0.131% L =750.000

Attachment 3

CL - Runway - LONGSECTION

SCALE: H 1:2000, V 1:200. DATUM: 225.000

G = 0.162% L =12.378

Chainage

Vertical Alignment

Proposed Ground Levels


Existing Ground Levels


Level Difference (Pr. - Ex.)

Report No. DS-2025-0028

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J. J. BATTISTON 100556268 2024-12-20



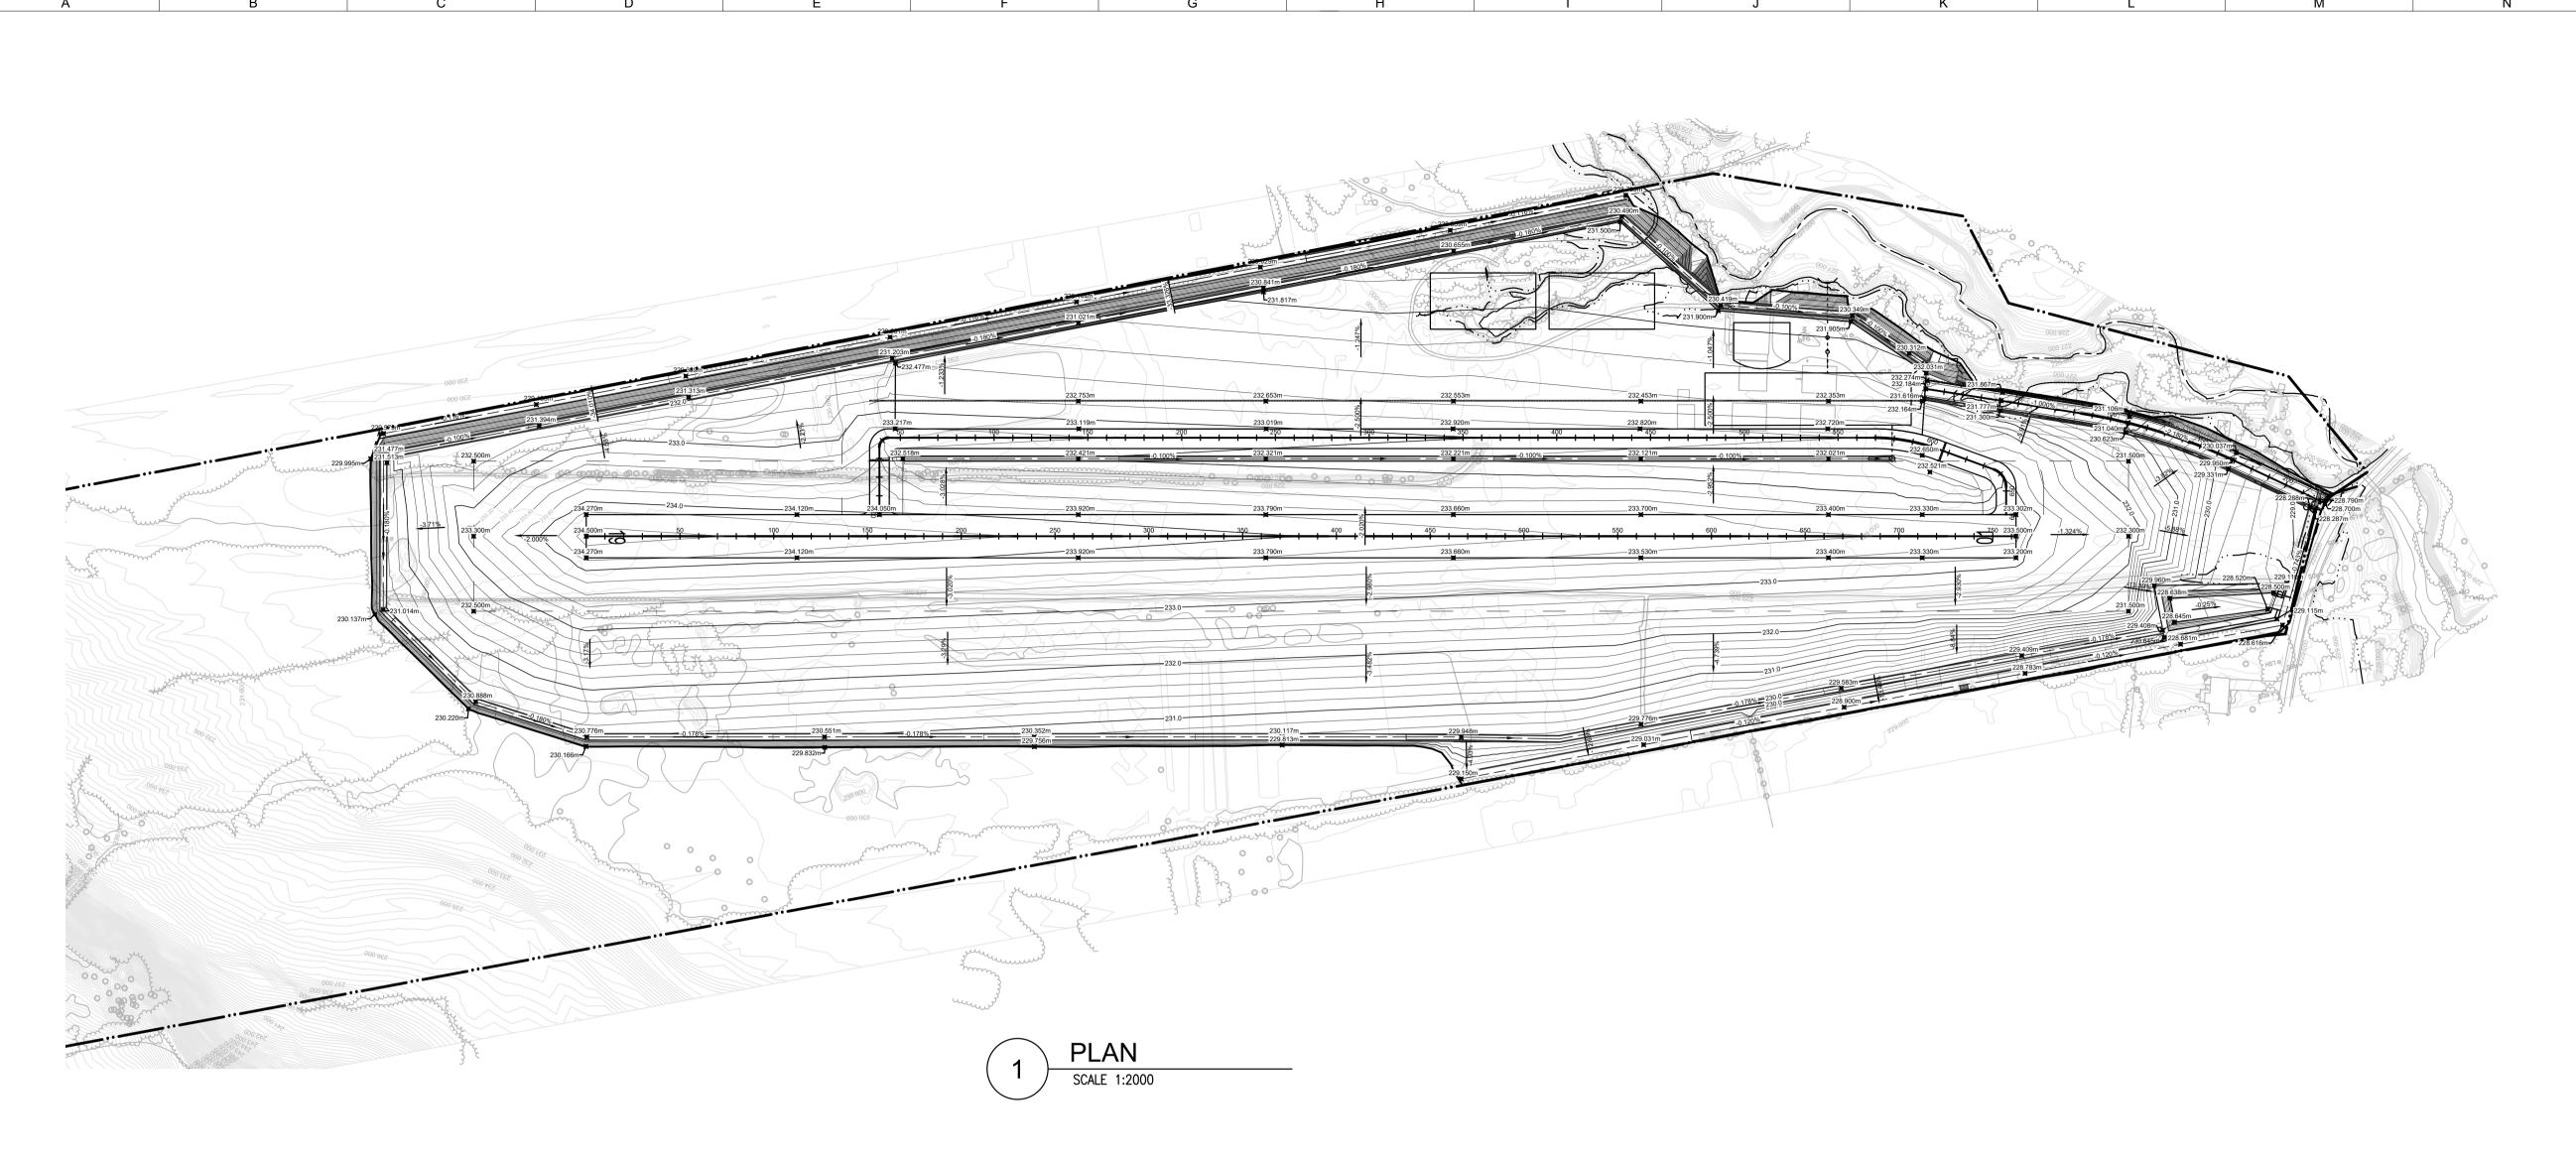
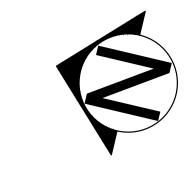
#### LEGEND

RUNWAY/TAXIWAY STRIP

GRADING LIMIT 232.500m

PROPOSED ELEVATION 230.000 EXISTING ELEVATION

> PROPOSED MAJOR CONTOUR PROPOSED MINOR CONTOUR

> > EXISTING GROUND

PROPOSED GROUND

1 20/12/2024 MT NK/BS JD FOR SAP APPROVAL 0 07/08/2024 MT NK/BS JD FOR REVIEW Issue Date Ву Chkd

### ARUP


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**BALDWIN AIRPORT** 

**IMPROVEMENTS** 

Key Plan



Drawing Title PLAN AND PROFILE SHEET 2 OF 2

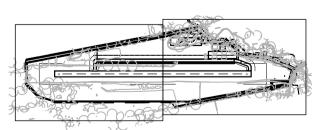AS INDICATED File Name

287943-ARUP-XX-XX-DR-C-XX-C004.DWG Drawing Status

**FOR REVIEW** 

287943-01 C004

CL - Taxiway - LONGSECTION SCALE: H 1:2000, V 1:200. DATUM: 225.000 234 233 232 231 230 229 228 227 226 225 Chainage L =14.721 A: 100.000 L: 34.555 L =31.713 Horizontal Alignment R: 5.000 L =36.001 L =525.558 L: 7.854 R: 10.000 L: 12.216 G =-1.500% L =28.500 G =-0.100% L =581.827 Vertical Alignment \_G =-2.000% L =36.937 L =15.355 Proposed Ground Levels Existing Ground Levels Level Difference (Pr. - Ex.)

LONGSECTION

SCALE HORIZ. 1:2000, VERT. 1:200

226 10.000 10.000 20.000 30.000 40.000 40.000 50.000 10.000 Chainage R: 300.000 Horizontal Alignment L: 84.780 L =83.939 L =54.288 R =6536.929 G =-1.000% G =-2.297% Vertical Alignment K =65.369 L =83.939 L =54.288 L =84.780 Proposed Ground Levels Existing Ground Levels Level Difference (Pr. - Ex.)

CL - Driveway - LONGSECTION

SCALE: H 1:2000, V 1:200. DATUM: 225.000

LONGSECTION SCALE HORIZ. 1:2000, VERT. 1:200

234

233

232

231

230


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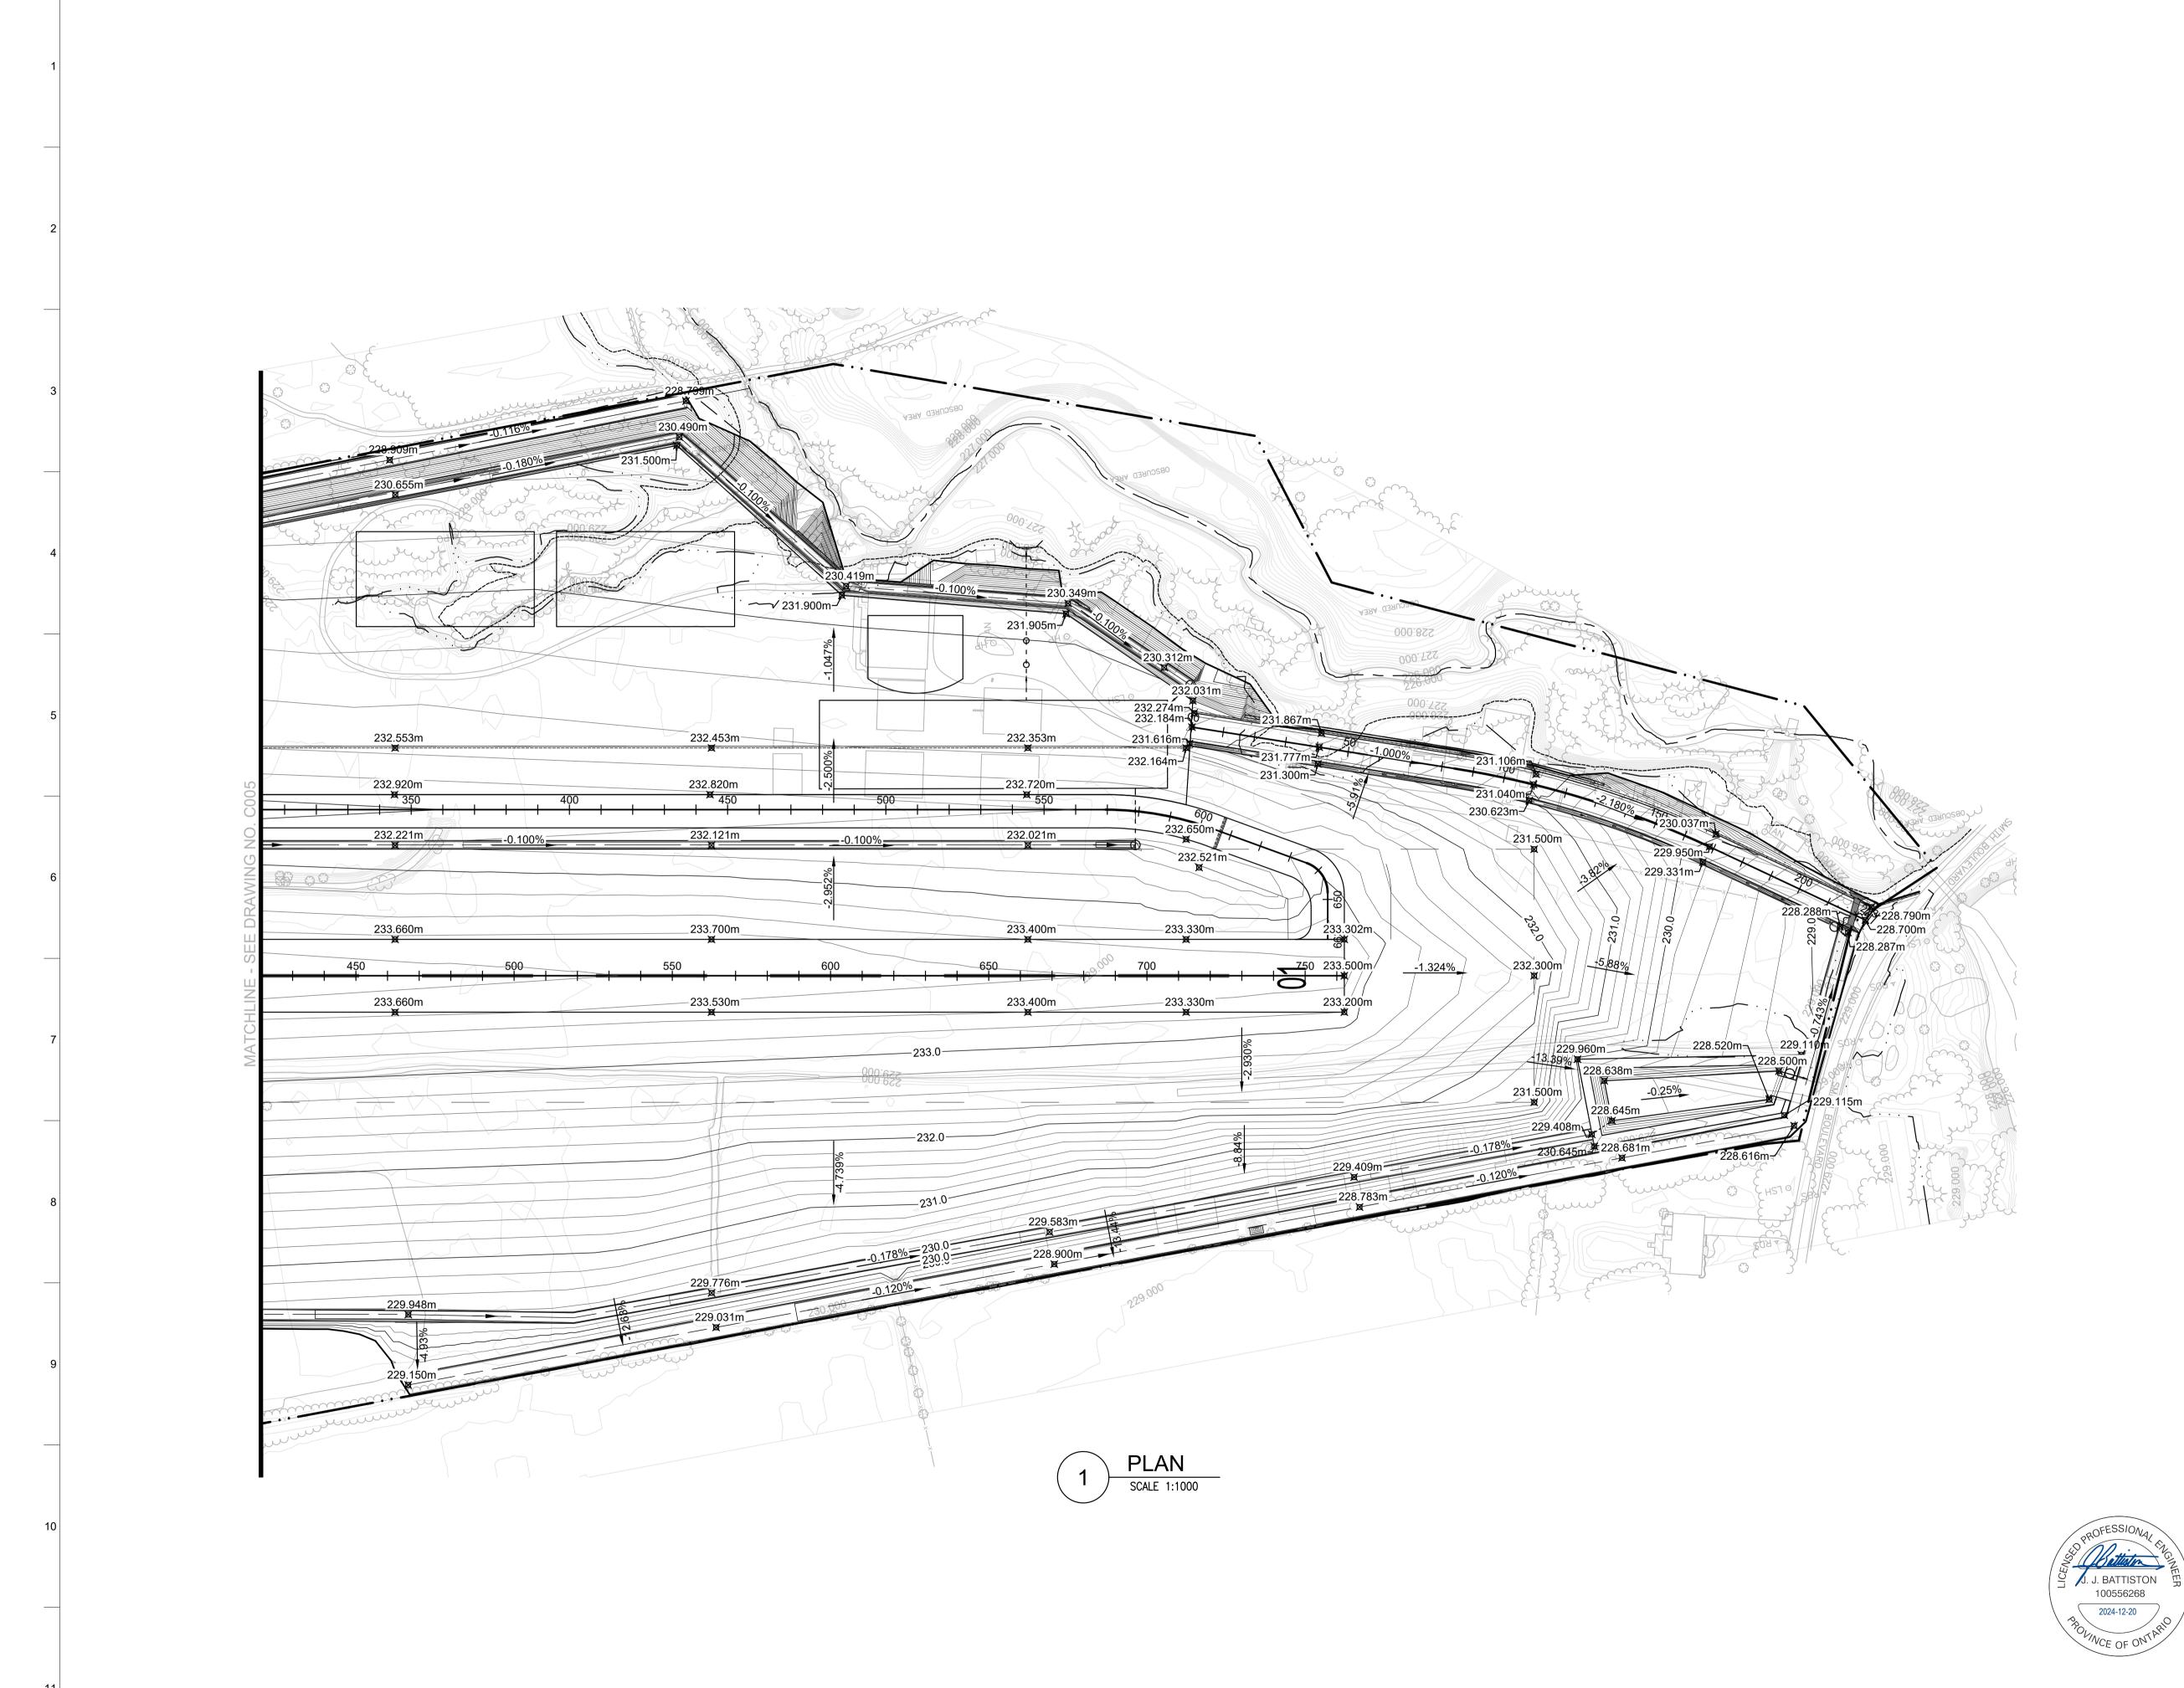
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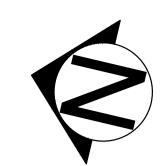
A1v

Issue



Attachment 3



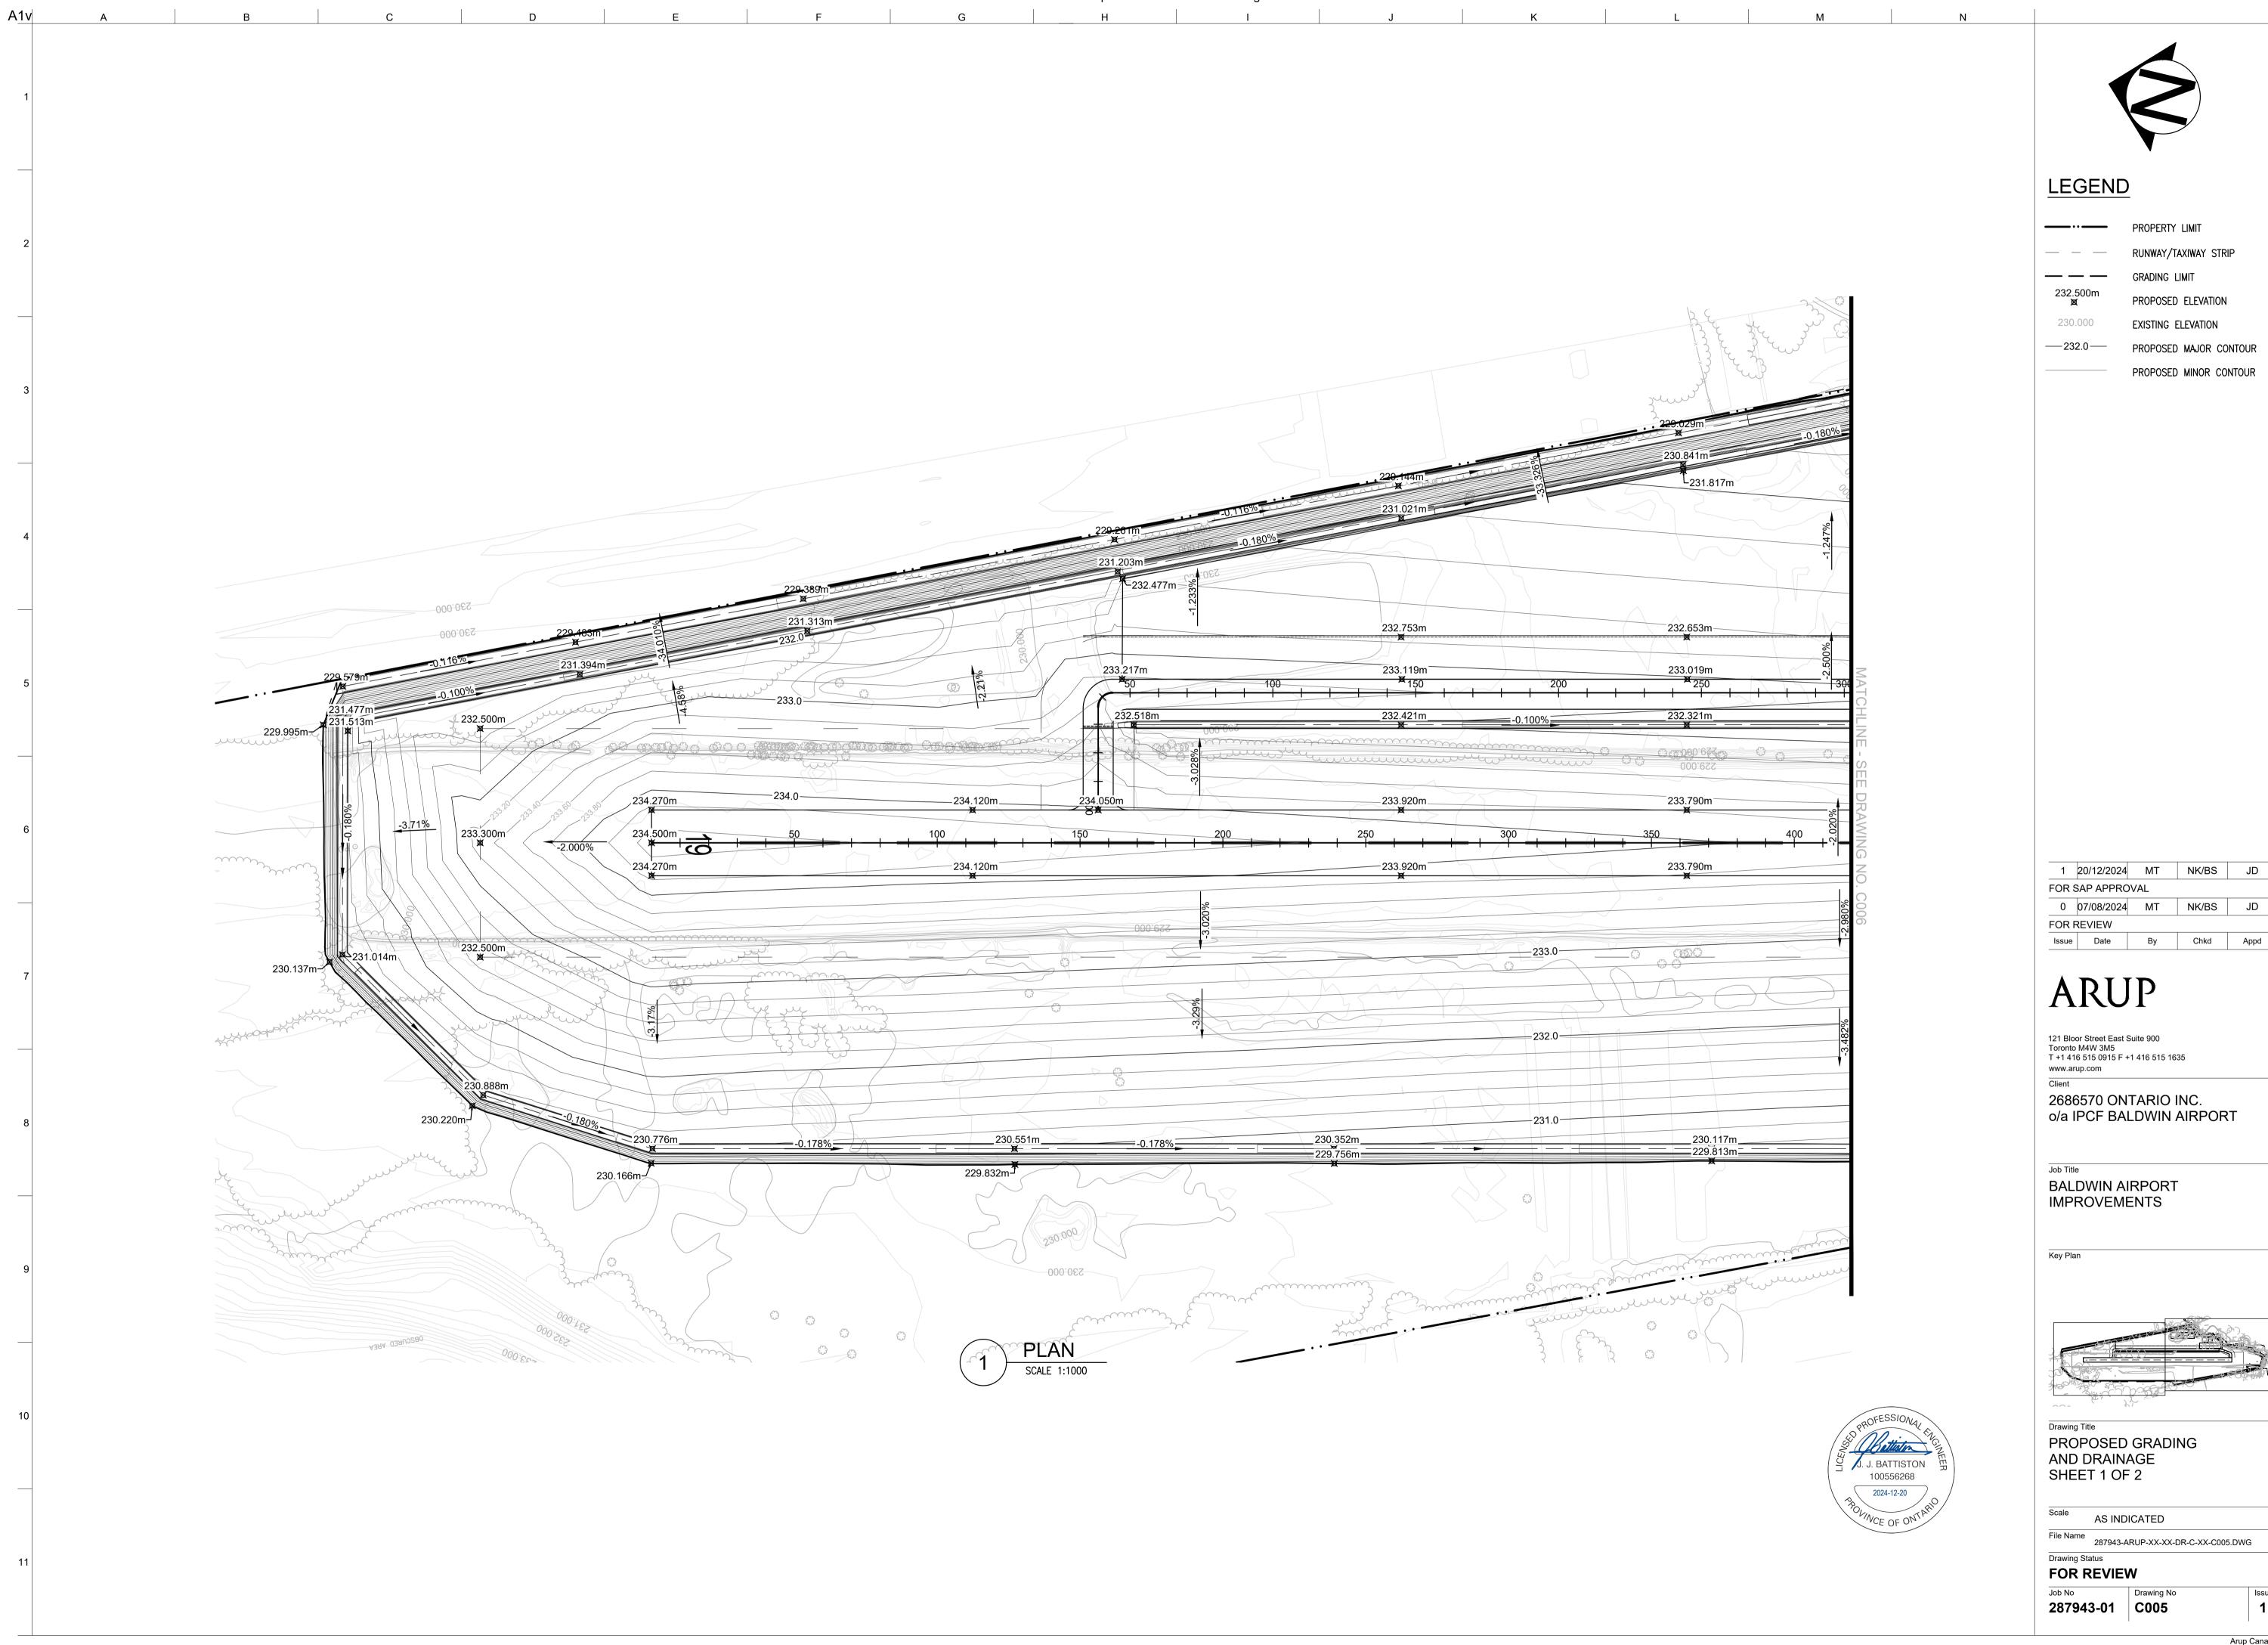

#### LEGEND

RUNWAY/TAXIWAY STRIP GRADING LIMIT PROPOSED ELEVATION

230.000 EXISTING ELEVATION PROPOSED MAJOR CONTOUR

PROPOSED MINOR CONTOUR

20/12/2024	MT	NK/BS	JD		
FOR SAP APPROVAL					
	7 V / L				
07/08/2024	MT	NK/BS	JD		
REVIEW					
Date	Ву	Chkd	Appd		
	SAP APPRO 07/08/2024 REVIEW	SAP APPROVAL 07/08/2024 MT REVIEW	SAP APPROVAL 07/08/2024 MT NK/BS REVIEW		


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**BALDWIN AIRPORT IMPROVEMENTS** 

Key Plan




Drawing Title PROPOSED GRADING AND DRAINAGE SHEET 2 OF 2

AS INDICATED File Name 287943-ARUP-XX-XX-DR-C-XX-C006.DWG

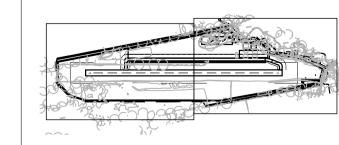
Drawing Status **FOR REVIEW** 

287943-01 C006

A1v

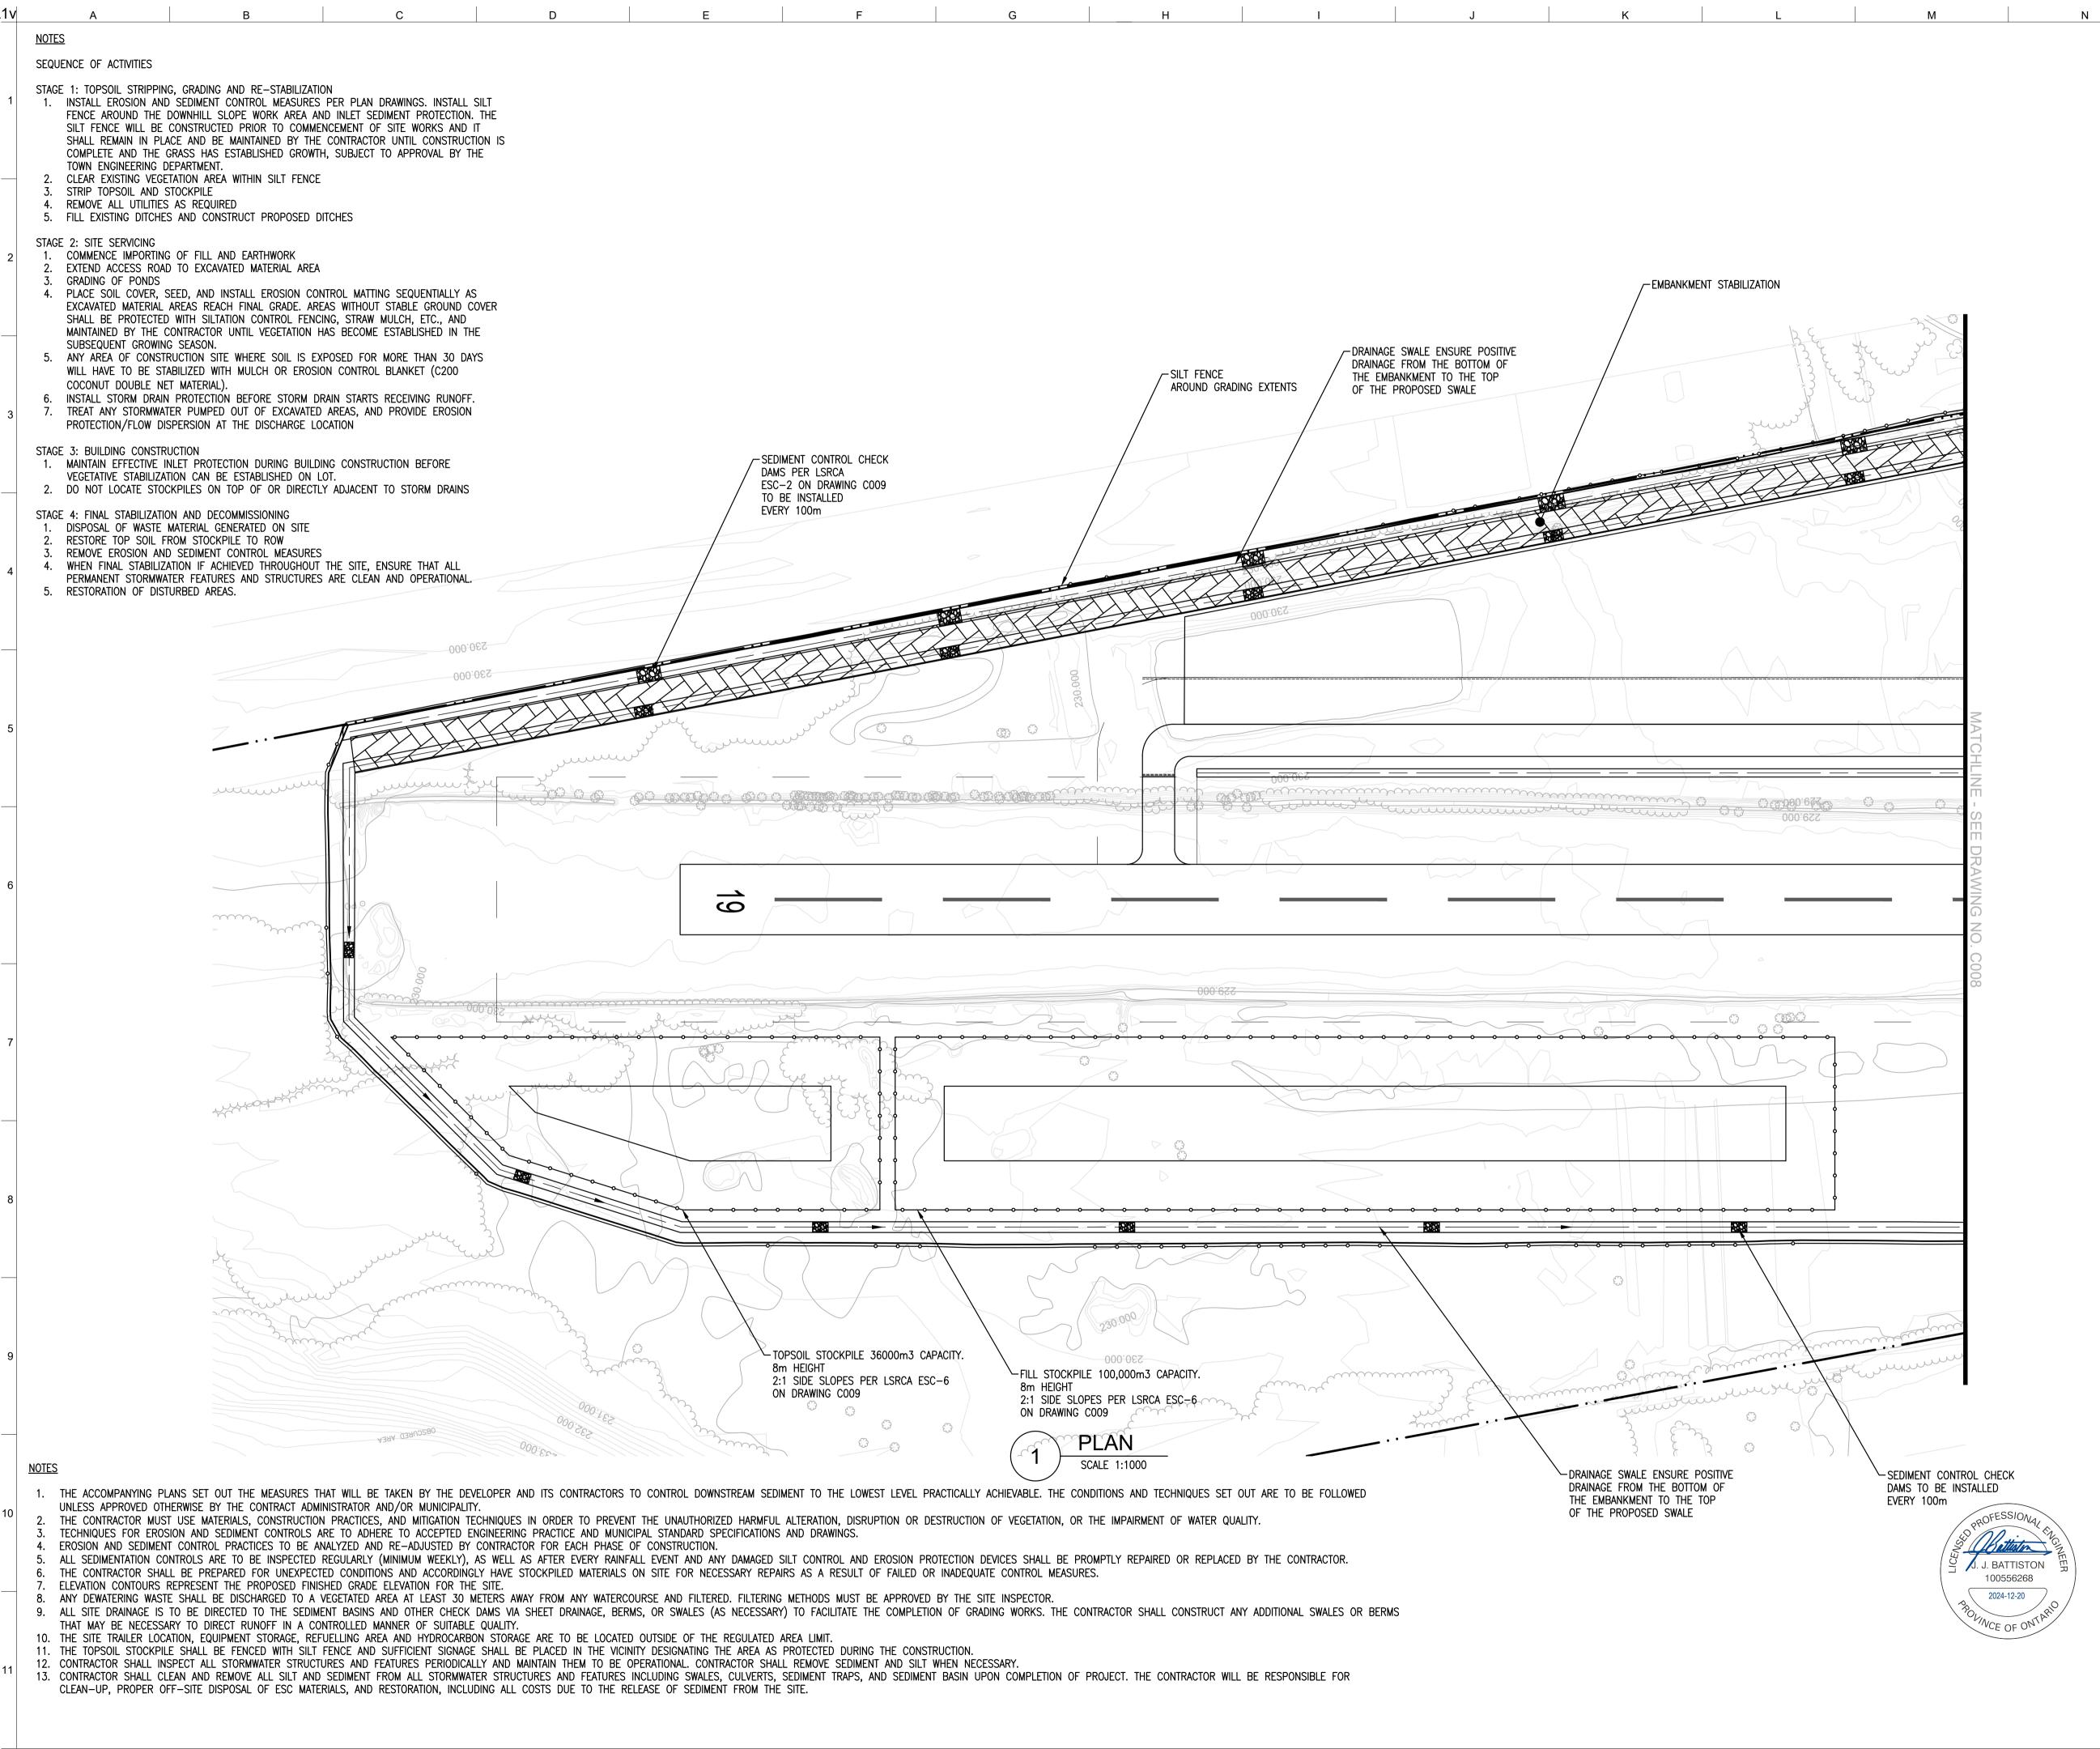

Attachment 3

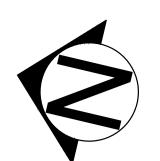

#### <u>LEGEND</u>

232.500m

PROPERTY LIMIT

RUNWAY/TAXIWAY STRIP

SILT FENCE

PROPOSED ELEVATION

230.000 EXISTING ELEVATION

30.0 PROPOSED MINOR CONTO

PROPOSED MAJOR CONTOUR

PROPOSED MINOR CONTOUR

STABILIZATION AREA

#### CONTINGENCY PLAN

- 1. IF UNFORESEEN EVENTS CAUSE THE STRATEGIES SET OUT IN THIS PLAN TO BE INSUFFICIENT OR INAPPROPRIATE TO MEET THE OBJECTIVE, THE CONTRACTOR IS EXPECTED TO RESPOND IN A TIMELY MANNER WITH ALL REASONABLE MEASURES CONSISTENT WITH SAFETY, TO PREVENT, COUNTERACT, OR REMEDY DOWNSTREAM SEDIMENTATION AND EROSION.
- 2. IF A SPILL OCCURS, IT SHALL BE REPORTED TO THE MINISTRY OF ENVIRONMENT AND CLIMATE CHANGE AND THE MINISTRY OF NATURAL RESOURCES. THE TOWN OF GEORGINA SHOULD ALSO BE NOTIFIED AT THE PHONE NUMBER 905–476–4301.
- 3. IF APPROVAL AGENCIES DETERMINE THAT LONG—TERM DAMAGE TO THE NATURAL ENVIRONMENT HAS OCCURRED DUE TO FAILURE OF THIS PLAN TO CONTROL SEDIMENTS, A RESTORATION PLAN WILL BE DEVELOPED BY THE CONTRACTOR, IN CONSULTATION WITH AND APPROVAL FROM THE APPROPRIATE AGENCIES, FOR INPLEMENTATION BY THE CONTRACTOR.

### HYDRO SEEDING

- ALL TEMPORARY EROSION AND SEDIMENT
   CONTROL SWALES, BERMS, AND SEDIMENT PONDS
   ARE TO BE HYDRO SEEDED IMMEDIATELY
   FOLLOWING CONSTRUCTION.

   ALL AREAS STRIPPED OF VEGETATIVE COVER FOR
- 2. ALL AREAS STRIPPED OF VEGETATIVE COVER FOR LONGER THAN 30 DAYS SHALL BE HYDRO SEEDED AS DIRECTED BY THE ENGINEER.
- HYDRO SEED MIX TO BE 48% ANNUAL RYE GRASS, 48% FALL RYE, AND 4% RED CLOVER (100 KG/HA) WITH FIBRATAC TACTIFIER OR APPROVED EQUIVALENT.

1	20/12/2024	MT	NK/BS	JD
FOR S	SAP APPRO	VAL		
0	07/08/2024	MT	NK/BS	JD
FOR F	FOR REVIEW			
Issue	Date	Ву	Chkd	Appd

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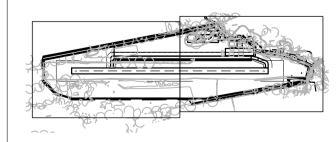
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BALDWIN AIRPORT IMPROVEMENTS

Key Plan



PROPOSED EROSION AND AND SEDIMENT CONTROL SHEET 1 OF 2

AS INDICATED


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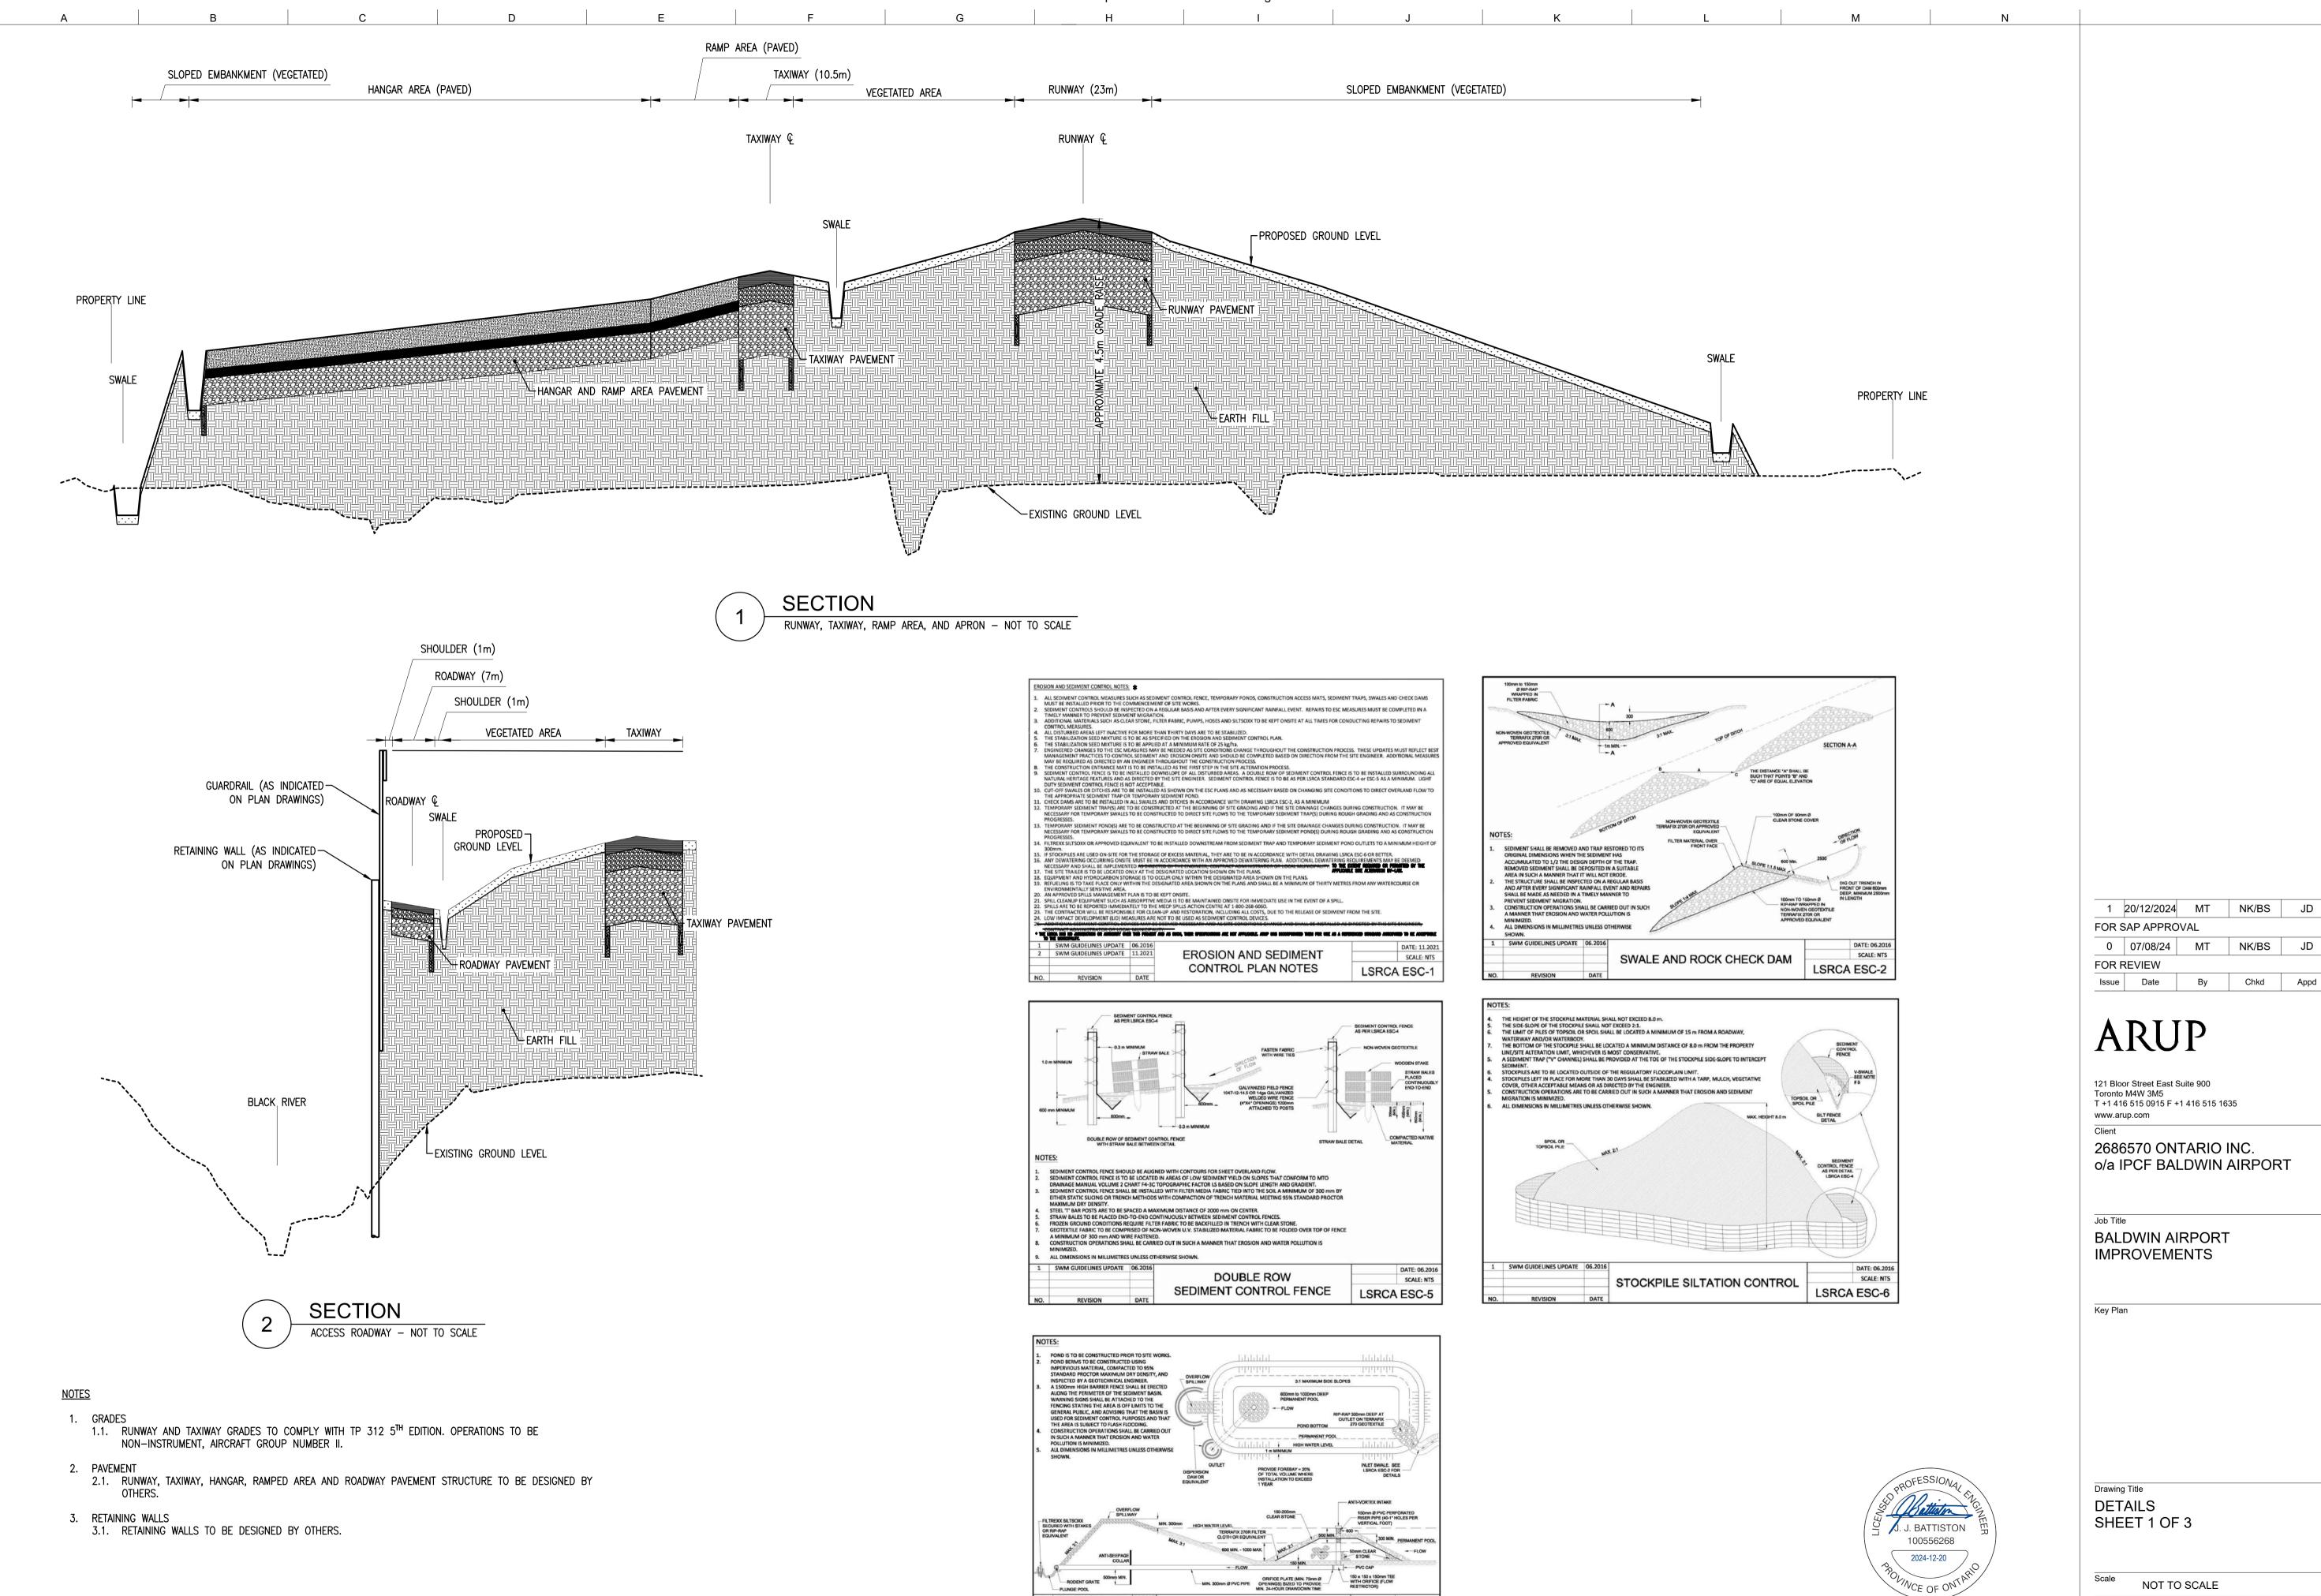
287943-ARUP-XX-XX-DR-C-XX-C007.DWG

FOR REVIEW

287943-01 C007

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Issue

File Name 287943-ARUP-XX-XX-DR-C-XX-C009.DWG

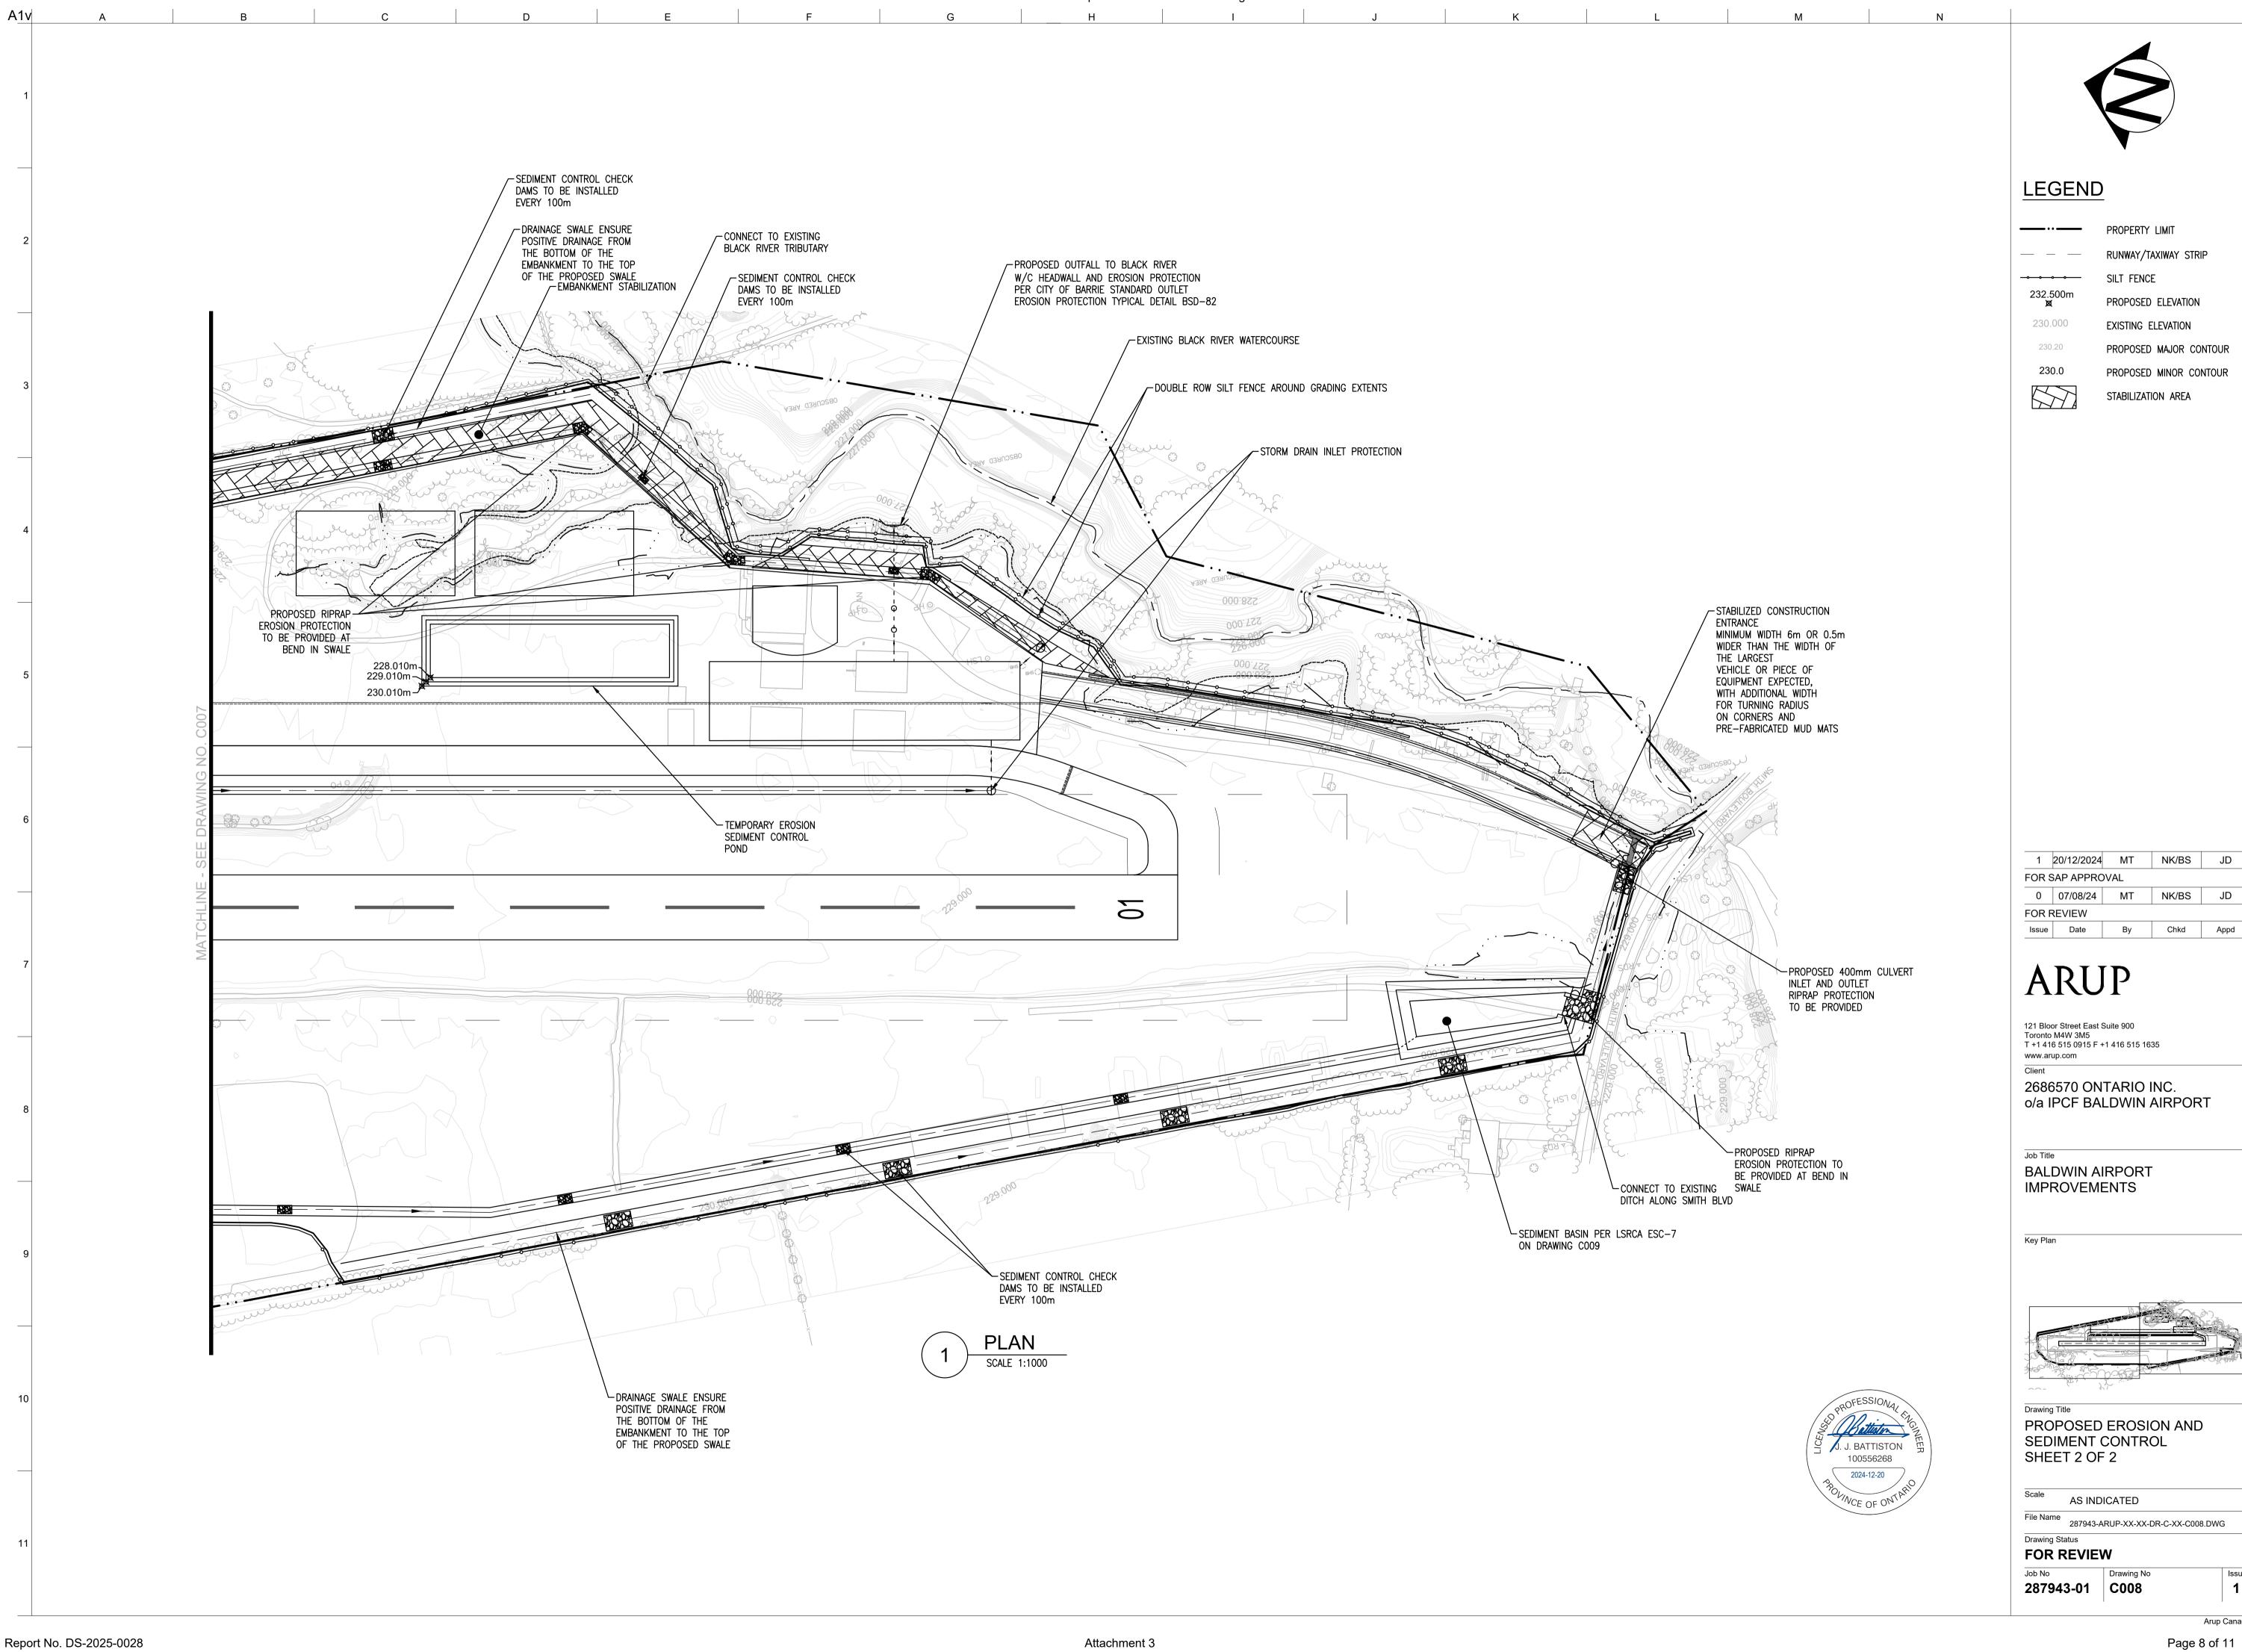**Drawing Status** 

**FOR REVIEW** 

287943-01 C009

Chkd

TEMPORARY SEDIMENT POND


AND OUTLET DETAILS

DATE: 06.2016

SCALE: NTS

LSRCA ESC-7

A1v

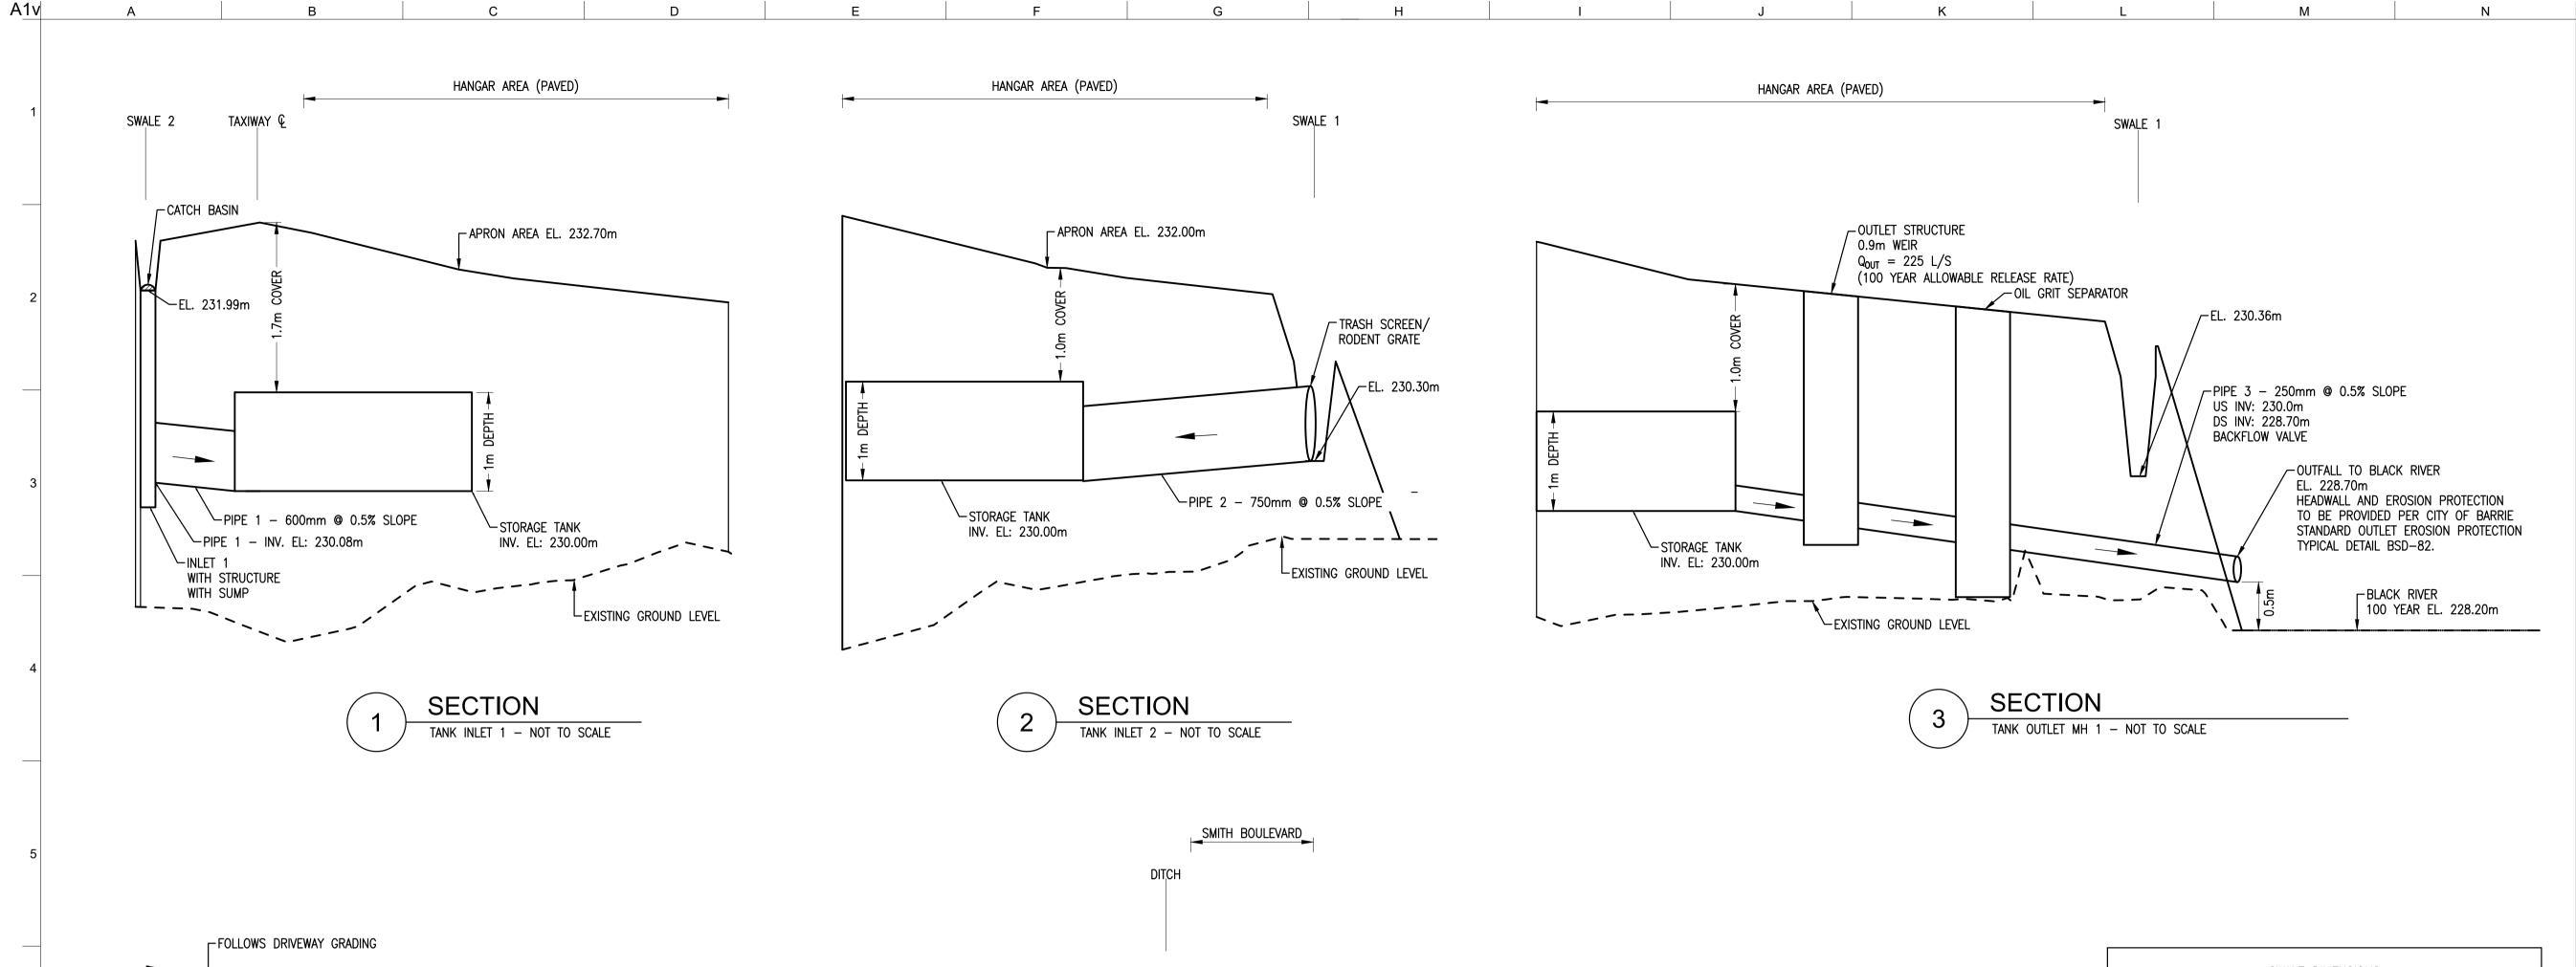

~250mm PIPE

←OUTLET CONTROL MAINTENANCE HOLE REFER TO DETAIL 1 RECONSTRUCTED 400mm

CULVERT

SEE TABLE		SWALE DI	MENSI
1 1 1	SWALE NO.	LONG. SLOPE (%)	вотт
	1	0.18	
	2	0.10	
	3	1.00	
TYPICAL SWALE SECTION		2.12	

TYPICAL SWALE SECTION NOT TO SCALE

<u>NOTES</u>

GRASS-LINED SWALE WITH A MINIMUM LONGITUDINAL SLOPE OF 0.1%
 RETURN PERIOD: 100 YEAR DESIGN STORM EVENT

	SWALE DI	MENSIONS	
SWALE NO.	LONG. SLOPE (%)	BOTTOM WIDTH (m)	MINIMUM DEPTH (m)
1	0.18	2.00	1.00
2	0.10	1.50	0.60
3	1.00	0.50	0.50
4	0.16	2.75	0.50
5	0.15 - ASSUMED CONSISTENT SLOPE	5.50	0.60
6	0.15 - ASSUMED CONSISTENT SLOPE	3.50	0.60

1	20/12/2024	MT	NK/BS	JD
FOR S	SAP APPRO	VAL		
0	07/08/24	MT	NK/BS	JD
FOR I	REVIEW			
Issue	Date	Ву	Chkd	Appd

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**BALDWIN AIRPORT IMPROVEMENTS** 

Key Plan

SHEET 2 OF 3

Drawing Title **DETAILS** 

NOT TO SCALE

File Name 287943-ARUP-XX-XX-DR-C-XX-C010.DWG Drawing Status **FOR REVIEW** 287943-01 C010

✓ WEIR SIZED FOR ALLOWABLE RELEASE RATE ✓ ORIFICE SIZED TO DETAIN WATER QUALITY VOLUME FOR 24 HRS <u></u>INCOMING OUTGOING FLOW

OUTLET STRUCTURE

SERIES OF CHECK DAMS

Lexisting ground level

**SWALE 3 SECTION** 

SECTION THROUGH OUTLET STRUCTURE - NOT TO SCALE

DETAIL OUTLET STRUCTURE - NOT TO SCALE



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Issue

