

LOCATION MAP



SUBJECT LAND


0 30 60 120 Meters




Proposed Childcare Location


Attachment 1 A02-24 (443 TQS) Pg 1 of 1

SITE PLAN

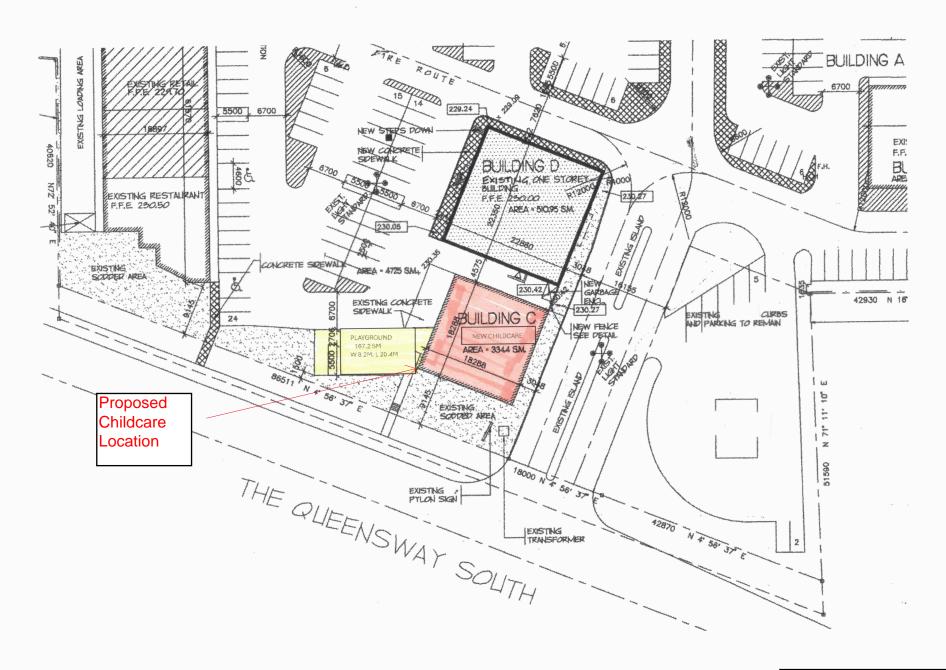

Attachment 2 A02-24 (443 TQS) Pg 1 of 2

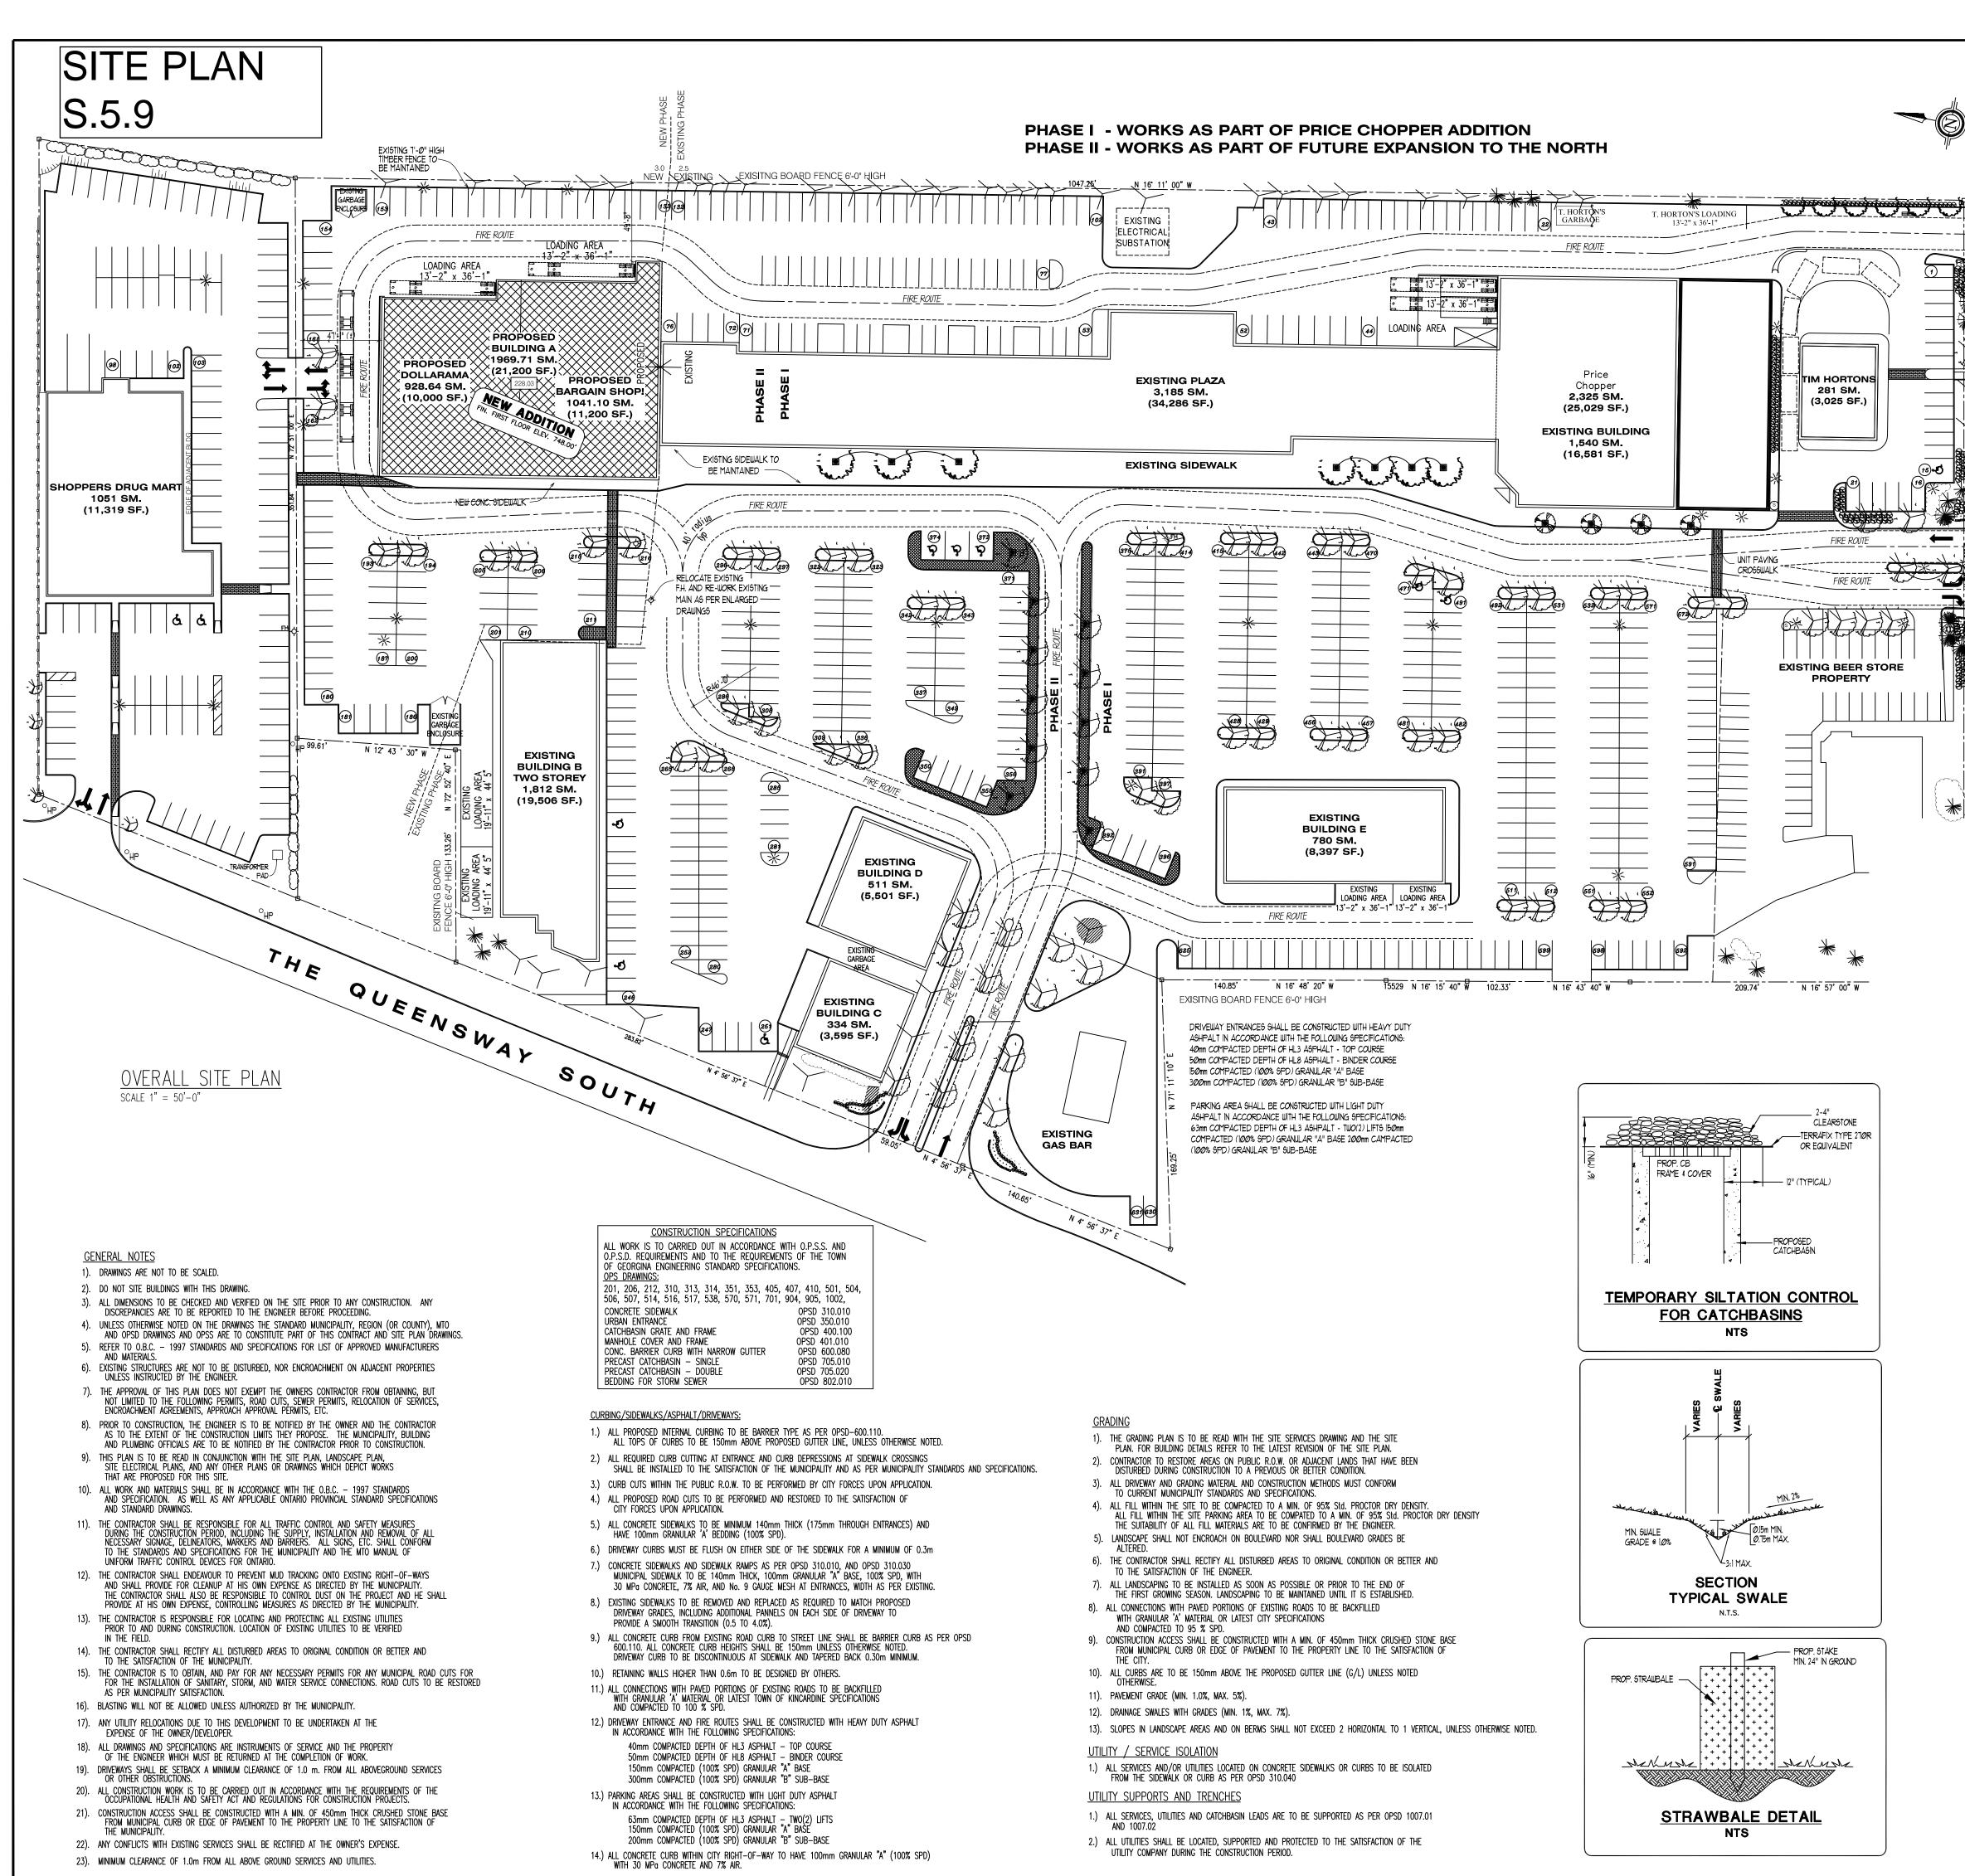

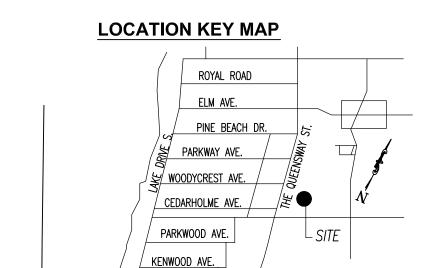

LAKEVIEW BLVD., TERRACE DRIVE

GLENWO		
SITE DATA		
SITE AREA:	49,130SM	12,141 ACRES
EXISITING SUPERMARKET AREA:	1,540 SM	16,581 SF
EVICTING DI III DING IIDII ADEA.	4.040.004	40 500 05
EXISTING BUILDING "B" AREA: EXISTING BUILDING "C" AREA:	1,812 SM	19,506 SF
	334 SM	3.595 SF
EXISTING BUILDING "D" AREA: EXISTING BUILDING "E" AREA:	511 SM	5,501 SF
EXISTING BUILDING E AREA: EXISTING TIM HORTONS "F" AREA:	780 SM 281 SM	8,397 SF 3.025 SF
EXISTING TIM HORTONS F AREA.	3,185 SM	34,286 SF
EXISTING PLAZA AREA	3,103 3101	34,200 SF
EXISTING BUILDING AREA:	8,443 SM	90,883 SF
LESS 10%	844 SM	9,083 SF
TOTAL EXISTING BUILDING AREA	7,599 SM	81,800 SF
EXISTING PARKING (2.5M X 5.5M) REQUIRED BEF	ORE ADDITION:	469 SPACES
(5.72 / 1000SF RATIO PROVIDED)		
PROPOSED PRICE CHOPPER ADDITION AREA	785 SM	8,450 SF
PROPOSED PRICE CHOPPER TOTAL AREA	2,325 SM	25,029 SF
PROPOSED BUILDING "A" ADDITION	1,969 SM	21,200 SF
TOTAL ADDITION ADEA.	0.754.004	00.045.05
TOTAL ADDITION AREA:	2,754 SM	29,645 SF
LESS 10%	275 SM	2,964 SF
TOTAL ADDITION AREA	2,479 SM	26,687 SF
NEW TOTAL BUILDING AREA	10,078 SM	108,482 SF
PARKING (3.0M X 5.7M) REQUIRED AFTER ADDITI	ON	569 SPACES
(5.50 / 1000 SF RATIO PROVIDED)		
PARKING PROVIDED AFTER ADDITION		625 SPACES

<u>STORM</u>

1.) ALL STORM SEWERS 375mmø AND SMALLER TO BE PVC SDR 35 IN ACCORDANCE WITH CSA-B182.2, ASTM D-2779 AND ASTM D-3034 OR LATEST REVISIONS. 450mmø AND LARGER TO BE ONCRETE IN ACCORDANCE WITH CSA A257.2, CLASS 65D OR LATEST REVISIONS. UNLESS OTHERWISE NOTED. ROOF TOP STORM LEADS 200mmø AND SMALLER TO BE PVC SDR 28.

2.) BEDDING FOR PVC STORM SEWERS AS PER OPSD 802.010, GRANULAR "A" COMPACTED TO 100% SPD.

3.) BEDDING FOR CONCRETE PIPE AS PER OPSD-802.030, CLASS B, GRANULAR 'A', COMPACTED TO 100% SPD. 4.) EXISTING SEWER INVERTS, MATERIAL TYPE, AND SIZE TO BE CONFIRMED ON SITE AT THE TIME OF CONSTRUCTION.

5.) ALL CATCHBASINS CONSTRUCTED IN FILL AREAS TO BE SUPPORTED IN 14 MPa. CONCRETE.

LOADING AREA PROVIDED (4.0M X 11M MIN.

6.) ALL RELOCATION, RECONSTRUCTION AND RESTORATION TO BE PERFORMED TO THE SATISFACTION

OF THE MUNICIPALITY OF KINCARDINE ENGINEERING DEPARTMENT. 7.) ALL CATCHBASINS SHALL BE INSTALLED IN ACCORDANCE WITH OPSD 705.010, ALL CATCHBASIN FRAMES AND COVERS AS PER OPSD 400.02.

8.) AT ALL CATCHBASIN & CATCHBASIN MANHOLE SAG POINTS INCLUDE TWO (2) 2.0m LONG, 100mmø
PVC SUBDRAINS WITH FILTER CLOTH. CAP ONE END AND CONNECT THE OTHER TO THE CATCHBASIN

OR CATCHBASIN MANHOLE.

9.) ALL EXISTING SEWERS ARE TO BE CONFIRMED ON SITE PRIOR TO CONSTRUCTION.

10.) ALL CONNECTIONS WITHIN PAVED PORTIONS OF EXISTING ROADS TO BE BACKFILLED WITH GRANULAR "A" MATERIAL OR AS PER LATEST TOWN OF KINCARDINE STANDARDS AND SPECIFICATIONS

11.) ALL STORM MANHOLE AND CATCH BASIN MANHOLE SIZES TO BE AS NOTED ON THE SITE GRADING AND DRAINAGE PLAN.

12.) ALL CATCHBASIN LEADS TO BE 300mmø PVC SDR 35 IN ACCORDANCE WITH CSA-B182.2, ASTM D-2779 AND ASTM D-3034 OR LATEST REVISIONS. (UNLESS OTHERWISE NOTED)

13.) THE CONTRACTOR IS TO CAP ALL STORM SERVICES 2.0 METRES AWAY FROM THE

PROPOSED BUILDING LINES UNLESS OTHERWISE NOTED. 14.) ALL 300mmø CONCRETE PIPE TO BE NON REINFORCED CONCRETE PIPE CLASS 3 (EXTRA STRENGTH) AS PER

ASTM C14 AND CSA 257.1. 15.) ALL TESTING OF STORM SERVICES TO BE IN ACCORDANCE WITH O.B.C. - 1997.

16.) ALL 450mmø PIPES AND UNDER REQUIRE A 600mm SUMP IN CATCHBASINS AND MANHOLES. BENCHING IS REQUIRED FOR PIPES 450mmø AND GREATER.

1.) ALL SANITARY SEWERS ARE TO BE PVC-SDR 28 IN ACCORDANCE WITH CSA-B182.2, ASTM D-2779 AND ASTM D-3034 OR LATEST REVISIONS, RUBBER GASKET. 2.) EXISTING SEWER INVERTS, MATERIAL TYPE, AND SIZE TO BE CONFIRMED ON SITE AT THE TIME OF CONSTRUCTION. 3.) ALL RELOCATION, RECONSTRUCTION AND RESTORATION TO BE PERFORMED TO THE SATISFACTION OF THE DIRECTOR OF ENGINEERING.

4.) ALL WORKS WITHIN CITY RIGHT-OF-WAY TO BE PERFORMED BY CITY FORCES UPON APPLICATION.

5.) PROVIDE WATER TIGHT COVERS FOR SANITARY MANHOLES LOCATED IN PONDING AREAS.

6.) BENCHING AS PER OPSD 701.021, TO CROWN OF PIPE.

7.) BEDDING FOR PVC SANITARY SEWERS AS PER OPSD 802.010, GRANULAR "A"

COMPACTED TO 100% SPD.

8.) SANITARY SERVICE TO BE CAPPED 2.0m FROM BUILDING. 9.) ALL CONNECTIONS WITH PAVED PORTIONS OF EXISTING ROADS TO BE BACKFILLED

WITH GRANULAR MATERIAL OR LATEST MUNICIPLALITY SPECIFICATIONS AND COMPACTED TO 100% SPD.

10.) ALL TESTING OF SANITARY SERVICES TO BE IN ACCORDANCE WITH O.B.C. - 1997.

1.) WATERMAIN PIPE TO BE PVC-DR 18 CL 150 CONFORMING TO CSA B137.3, INCLUDING No. 8 TRACER WIRE BETWEEN HYDRANTS OR OTHER CONDUCTING APPURTENANCES. PIPE SHALL HAVE A MINIMUM COVER OF 1.8m. ALL WATERMAIN JOINTS TO BE APPROVED PUSH-ON. MECHANICAL OR FLANGE TYPE JOINTS AS REQUIRED FOR

1000 kPa RATED PRESSURE. CORROSION PROTECTION FOR ALL FITTINGS, VALVES AND HYDRANTS (HYPROTEC OR 2.) DOMESTIC WATER SERVICE TO BE 50mmø TYPE "K" SOFT COPPER.

3.) BEDDING AS PER TOWN OF KINCARDINE STANDARD SD-25.

4.) ALL WATERMAIN FITTINGS AND APPURTENANCES TO BE SELECTED FROM TOWN OF KINCARDINE APPROVED MATERIAL LIST FOR WATERMAINS.

5.) WATERMAINS SHALL HAVE A MINIMUM VERTICAL SEPARATION OF 0.5m AND HORIZONTAL SEPARATION OF 2.5m BETWEEN ANY SEWER OR MANHOLE. 6.) ALL WORKS WITHIN CITY RIGHT-OF-WAY TO BE PERFORMED BY CITY FORCES UPON APPLICATION. 7.) CONTRACTOR TO CONFIRM THE SIZE AND MATERIAL TYPE OF EXISTING WATER SERVICE AND WATERMAIN PRIOR

TO COMMENCING ANY WORK. 8.) EXISTING WATERMAIN OBVERTS TO BE CONFIRMED ON SITE AT THE TIME OF CONSTRUCTION. 9.) WATER SERVICE INSTALLATION AS PER O.B.C. - 1997, 50mmø TYPE"K" SOFT COPPER WATER SERVICE 10.) WATER SERVICE TO BE CAPPED 2.0m FROM BUILDING.

11.) ALL RELOCATION, RECONSTRUCTION AND RESTORATION TO BE PERFORMED TO THE SATISFACTION

OF THE DIRECTOR OF ENGINEERING.

12.) ALL CONNECTIONS WITH PAVED PORTIONS OF EXISTING ROADS TO BE BACKFILLED WITH GRANULAR "A" MATERIAL OR AS PER LATEST TOWN OF KINCARDINE SPECIFICATIONS.

13.) FLUSHING, SWABBING, AND TESTING OF WATERMAIN AS PER ONTARIO PROVINCAL STANDARD SPECIFICATIONS 14.) VALVE AND BOX TO BE INSTALLED AS PER OPSD 1101.02.

15.) HYDRANTS TO BE INSTALLED AS PER OPSS, WITH CATHODIC PROTECTION AS PER CITY STANDARDS.
ALL HYDRANTS SHALL CONFORM TO AWWA SPECIFICATIONS C502-64. THE DIRECTION SHALL BE COUNTER CLOCKWISE AND THEY SHALL HAVE 2 63.5mm NOZZLES AND 1 100mm STORTZ CONNECTION. HYDRANTS TO BE PAINTED RED WITH MEDIUM GREEN PORTS AS PER TOWN OF KINCARDINE STANDARD SD-25A. 16.) THRUST BLOCKING AS PER OPSD-1103.01 AND 1103.02.

Attachment 2 A02-24 (443 TQS) Pg 2 of 2

E	08/26/06	MODIFIED RADIUS TO 40'	GD	RED
D	07/26/06	GENERAL REVISIONS	GD	RED
С	01/30/06	GENERAL REVISIONS	GP	RED
В	09/12/05	FOR BUILDING PERMIT	GP	RED
A	09/11/05	FOR CLIENT REVIEW	GP	RED
No.	Date:	Revision / Issued	D'wn.	Ch'd.

GENERAL NOTES HIS DRAWING SHALL BE USED ONLY FOR:

TENDER CONSTRUCTION

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formation shown on this drawing, are for use on this project only, and shall not be used otherwise without written

T IS THE CONTRACTOR'S RESPONSIBILITY TO: . USE FIGURED DIMENSIONS IN PREFERENCE TO

. VERIFY AND CHECK ALL DIMENSIONS PRIOR TO AND DURING CONSTRUCTION. 3. DETERMINE LOCATIONS OF EXISTING SERVICES.



PROJECT

9 SPACES

1551 CATERPILLAR ROAD SUITE #202 MISSISSAUGA ON L4X-2Z6

(905) 949-5252 (905) 949-5233 PROPOSED BUILDING EXPANSION AT

GLENWOODS PLAZA FOR ATAVUS ENTERPRISES

KESWICK, ONTARIO

Drawing Title:

Overall Site Plan and Specifications



Licensed to Practice in Ontario, New Brunswick askatchewan, Alberta, Manitoba and British Columbia Toll Free: 866.636.2707 N7S 3Y6 rdale@redaleltd.ca

Date Drawn: July 26,2006 1"=50'-0" Drawn By: G. Dale Design By: G. Dale Checked By: R. Dale

> R.E. Dale Limited Project Number 06-0686

Drawing Number:


Site Photos





Attachment 3 A02-24 443 TQS Page 1 of 2



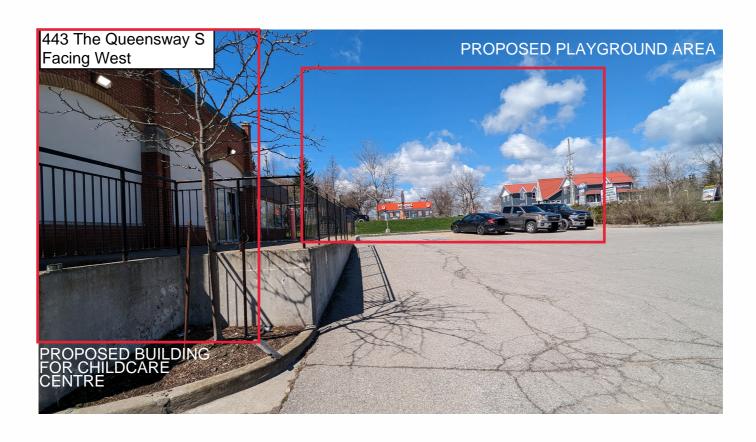

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Consolidated Comments for A02-24 - 443 The Queensway South

		nsolidated Comments for A02-24 - 443 The Queensway South
Department/Agency	Date Received	Response:
Building Division	May 3, 2024	A building permit for a change of use is required. A full review will take place at the time of building permit submission
Duilding/Dlumbing Incoastor		
Building/Plumbing Inspector Clerks Division	<u> </u>	
CIETRS DIVISION		
Community Services		
Development Engineering	May 2, 2024	See Attached
Policy Planning	May 2, 2024	See Attached
Economic Development		No Objection, Economic Development and Tourism
Georgina Fire Department	April 25, 2024	The Georgina Fire Department has no objections to this minor variance.
Municipal Law		
Operations & Infrastructure		
Tax & Revenue	April 22, 2024	No Tax Concerns
Bell Canada		
Canada Post Corporation (CPC)		
Chippewas of Georgina		
C.N. Business Development & Real Estate		
Enbridge Gas		
Hydro One		
, 4		
Lake Simcoe Region Conservation Authority (LSRCA)		
Ministry of the Environment		
Ministry of Health and Long-term Care		
Ministry of Municipal Affairs & Housing		
Ministry of Transportation		
Monavenir Catholic School Board		
MPAC	1	
Ontario Power Generation		
Rogers		
Southlake Regional Health Centre		
York Catholic Separate District School Board		
York Region - Community Planning &	May 1, 2024	Comment:
Development Services		The fenced playground as proposed appears to be located within the 18 metres setback York Region is protecting for this section of The Queensway South. The playground needs to be located approximately 1.5-2 metres to the east of the existing property line so that is out of the protected setbacks. Condition of Approval The property is located on The Queensway South which is a Regional Road as identified on Map 11 of the YROP-2022 and protects for a road widening of up to 36 metres right-of-way. All setbacks will need to be measured from 18 meters offset from centreline of construction of The Queensway South.
York Region District School Board		
York Regional Police		

Attachment 4 A02-24 443 TQS Page 1 of 5 **To:** Matthew Ka, Secretary Treasurer - Committee of Adjustments

From: Michelle Gunn, Development Engineering Clerk

cc: Mike lampietro, Manager, Development Engineering

Cory Repath, Sr. Development Inspector

Vikum Wegiriya, Jr. Development Technologist Matthew DeLuca, Jr. Development Inspector Laura Taylor, Operations Administrative Assistant

Date: April 30th, 2023

Re: MINOR VARIANCE A02-24

443 The Queensway South

Plan Concession 3, Lot 6, Part 5 of RS65R8344 Parts 4-8 of RS65412426

ROLL NO.: 146-659

The Development Engineering Division has no objection to Minor Variance Application No. A02-24, subject to the following **condition(s)** being fulfilled to the Engineering Development Division's satisfaction:

- 1. The Owner will be required to enter into a Development Agreement including but not limited to:
 - a. Amending the existing approved site plan agreement S.5.9.
 - b. A record of site condition

All to the satisfaction of the Town's Development Engineering Division.



Interoffice Memorandum

DEVELOPMENT DIVISION

Monika Sadler

To: Planner I, Development Services

Justine Burns

From: Senior Landscape Architect

Development Services Department

CC:

Date: May 2, 2024

Re: A02-24

I have reviewed the application and my comments are as follows;

General:

1. I am not in support of this application as it is.

Urban Design:

- 2. If the application is to be approved however, the following requirements apply;
 - The location of the playground should be one with the building design, currently it is represented separately. This request is due to safety concerns, primarily as the current playground is proposed next to a parking lot which is frequented by many users separate to that of the child care. The other major concern is with the constraints with the actual site. The proposed location would require the children and staff to exit the building cross a public walkway to enter the playground.

Recommendation:

A circulation plan with gate locations as well as buffers, playground locations and the like must be provided. The ideal relocation for the playground area would be closer to the building, possibly repurpose the front entry concrete area and enclose it, or put it on the south side of the current pathway right next to the

Attachment 4 A02-24 443 TQS Page 3 of 5 building on the west side. Children should not be crossing a public path or a public parking to get to play areas. Sloping can be incorporated into the play elements such as balance challenges and retaining that double as play features. If the playground stayed on the south side of the pathway and right against the building it would allow for easy access for children from building to play elements and keep them tucked away from the parking lot so long as adequate height fencing was implemented along the entrance of the Plaza and The Queensway. The applicant would also have to exhibit that all playground standards have been met. (see attached photos)





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 A landscaping buffer is not proposed in the current plan between the parking lot and the playground area, or on the east side of the Queensway. There is only 1500mm suggested in this location. Landscape buffers should be 2000mm minimum.

Recommendation:

The recommendation would again be to move the playground to the building, the way the space is programmed should be evaluated through a site plan.